# APPLICABLE COLORADO CODES

2018 INTERNATIONAL BUILDING CODE 2018 INTERNATIONAL RESIDENTIAL CODE 2018 INTERNATIONAL MECHANICAL CODE 2018 INTERNATIONAL PLUMBING CODE 2018 INTERNATIONAL FUEL GAS CODE 2018 INTERNATIONAL ENERGY CONSERVATIVE CODE 2020 NATIONAL ELECTRIC CODE 8 CCR 1302-14 ADMINISTRATIVE RULES

#### **DESIGN CRITERIA**

#### SITE LOCATION:

LA PLATA COUNTY, CO LATITUDE: 37.70 N **ELEVATION: 6500 FT** 

#### **CLIMATE ZONE: 5B**

<ol> <li>OCCUPANCY CLASS</li> <li>TYPE OF CONSTRUCTION</li> <li>GROUND SNOW LOAD</li> <li>ROOF SNOW LOAD</li> <li>ROOF SNOW LOAD</li> <li>WIND SPEED (Vult)</li> <li>WIND SPEED (Vasd)</li> <li>SPECIAL WIND ZONE</li> <li>SEISMIC CATEGORY</li> <li>WEATHERING</li> <li>FROST LINE DEPTH</li> <li>TERMITE</li> <li>WINTER DESIGN TEMP</li> <li>SUMMER DESIGN TEMP</li> <li>FLOOD HAZARDS</li> </ol>	R-3 V-B 57.0 PSF 40.0 PSF 115 MPH (EXPOSURE C) 90 NO B SEVERE 32" YES 4° F 86° F DETERMINED BY LOCAL AUTHORITY HAVING JURIS PROJECT LOCATION
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#### NOTE:

THIS STRUCTURE MUST NOT BE SITED IN A LOCATION THAT EXCEEDS THE LISTED DESIGN CRITERIA. ITEMS INSTALLED ON SITE ARE NOT INSPECTED BY, OR ARE THE RESPONSIBILITY OF, THE MANUFACTURER. THIS INCLUDES, BUT IS NOT LIMITED TO, INTERIOR AND EXTERIOR LIGHT BULBS, WHOLE HOUSE VENTILATION SYSTEMS, BLOWER DOOR TESTING, COMMUNICATION TERMINAL, PLUMBING CONNECTIONS TO MAIN WASTE DRAIN, STAIR RAILINGS, AND APPLIANCES.

AN AUTOMATIC SPRINKLER SYSTEM SHALL BE INSTALLED IN ONE AND TWO FAMILY DWELLINGS AND TOWNHOUSES AS REQUIRED BY THE LOCAL JURISDICTION WHERE THE HOME WILL BE SET.


NO SITE PROVIDED BY MANUFACTURER. MINIMUM ALLOWABLE SETBACK DISTANCES TO PROPERTY LINES OR ADJACENT BUILDINGS ON THE SAME LOT SHALL BE COORDINATED BY ARCHITECT OF RECORD, OR CIVIL ENGINEER.

### **GENERAL NOTES**

- 1. THESE DRAWINGS AND THE DESIGN SHOWN HAVE BEEN PREPARED FOR THIS SPECIFIC PROJECT AND IS THE SOLE PROPERTY OF FADING WEST BUILDING SYSTEMS, LLC. ANY REPRODUCTION, COPYING, OR USE BY OTHERS, FOR THIS PROJECT OR ANY OTHER IS PROHIBITED WITHOUT PRIOR WRITTEN CONSENT OF FADING WEST BUILDING SYSTEMS, LLC. ANY PROHIBITED USE OF THSE DRAWINGS IS SUBJECT TO LEGAL ACTION.
- 2. SCOPE OF WORK NOT COMPLETED IN THE FACTORY IS DESIGNATED WITH COLOR CODIFICATION AND IS NOT A PART OF THIS SUBMITTAL PACKAGE. ITEMS TO BE INSTALLED OR CONSTRUCTED ON SITE ARE THE RESPONSIBILITY OF THE GENERAL CONTRACTOR OR OWNER.
- 3. THESE PLANS SHOW ONE ORIENTATION OF THE PROPOSED DESIGN. UNITS MAY BE MIRRORED ON SITE TO ACCOMODATE SITE PLANS AS NECESSARY. IN THE CASE WHERE THIS DESIGN IS MIRRORED, ALL DIMENSIONS, LOCATIONS, AND COMPONENTS SHALL BE THE SAME RELATIVE TO THE NEW ORIENTATION OF THE PLAN AND ELEVATIONS.
- 4. PROJECTS DESIGNED TO NEWER CODES THAN THE 2018 IRC/IBC SHALL COMPLY WITH BOTH 2018 AND NEWER CODE, ADHERING TO THE STRICTER OF THE TWO WHERE APPLICABLE.

# **IGNACIO - ROCK CREEK**

SHAVANO MASTER UNIT SET

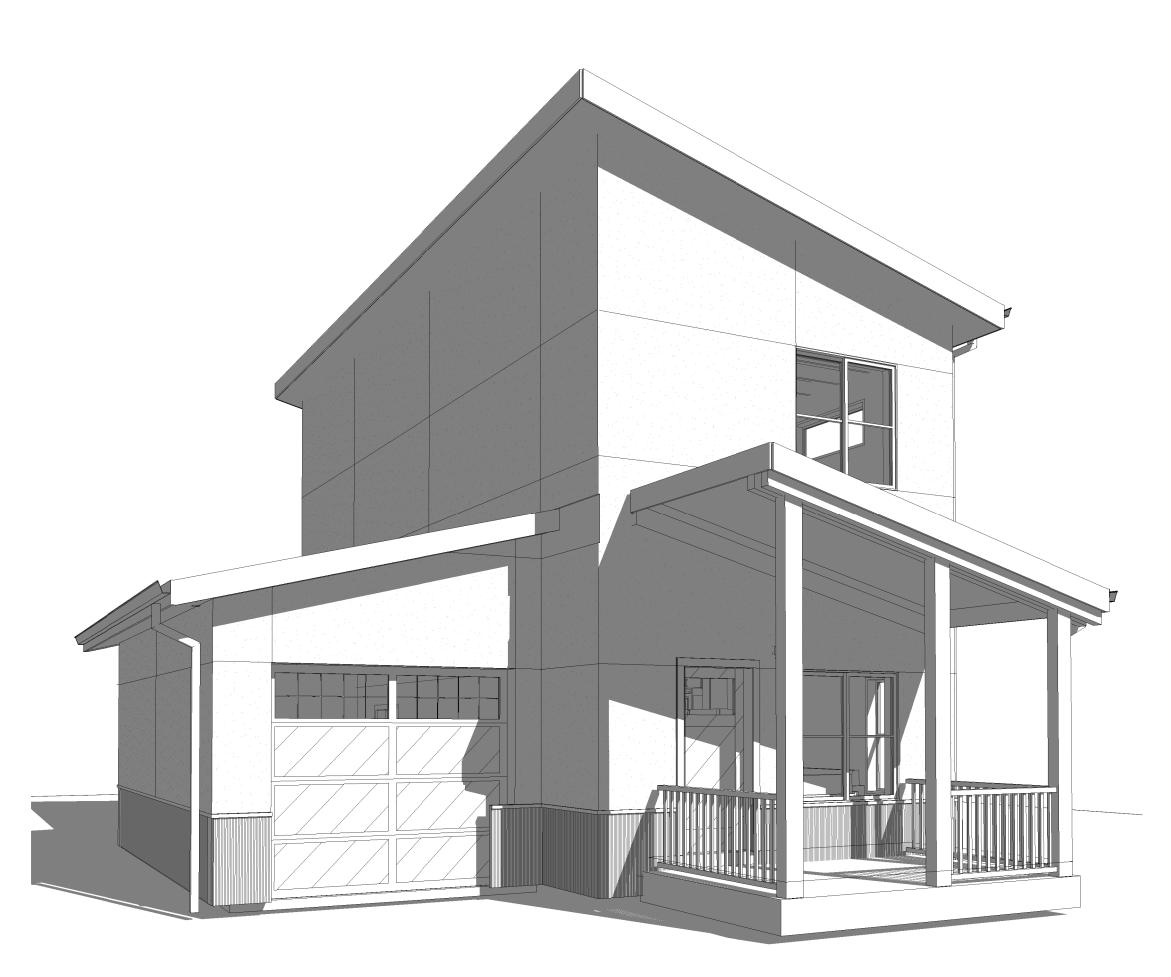

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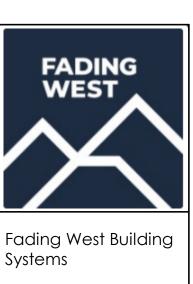
# **INSULATION R-VALUES:**

PER 2018 IECC TABLE C402.1.3

TABLE R402.1.2 INSULATION AND FENESTRATION REQUIREMENTS BY COMPONENT<sup>a</sup>

CLIMATE ZONE	FENESTRATION U-FACTOR <sup>b</sup>	SKYLIGHT <sup>b</sup> <i>U-</i> FACTOR	GLAZED FENESTRATION SHGC <sup>b, e</sup>	CEILING <i>R</i> -VALUE	WOOD FRAME WALL <i>R</i> -VALUE	MASS WALL <i>R</i> -VALUE <sup>i</sup>	FLOOR <i>R</i> -VALUE	BASEMENT <sup>C</sup> WALL <i>R</i> -VALUE	SLAB <sup>d</sup> <i>R</i> -VALUE & DEPTH	CRAWL SPACE <sup>c</sup> WALL <i>R</i> -VALUE
1	NR	0.75	0.25	30	13	3/4	13	0	0	0
2	0.40	0.65	0.25	38	13	4/6	13	0	0	0
3	0.32	0.55	0.25	38	20 or 13+5 <sup>h</sup>	8/13	19	5/13 <sup>f</sup>	0	5/13
4 except Marine	0.32	0.55	0.40	49	20 or 13+5 <sup>h</sup>	8/13	19	10/13	10, 2 ft	10/13
5 and Marine 4	0.30	0.55	NR	49	20 or 13+5 <sup>h</sup>	13/17	30 <sup>g</sup>	15/19	10, 2 ft	15/19
6	0.30	0.55	NR	49	20+5 <sup>h</sup> or 13+10 <sup>h</sup>	15/20	30 <sup>g</sup>	15/19	10, 4 ft	15/19
7 and 8	0.30	0.55	NR	49	20+5 <sup>h</sup> or 13+10 <sup>h</sup>	19/21	38 <sup>g</sup>	15/19	10, 4 ft	15/19

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Architecture & **Engineering Studio** 

1950 McCormick St. Buena Vista, CO 81211

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2024-03IG

ARCH SHEET LIST			
Sheet Number Sheet Name			
A002	COVER PAGE		
A005	ASSEMBLIES		
A100	FLOOR PLANS - LEVEL 1		
A101	FLOOR PLAN - LEVEL 2		
A400	WINDOW/DOOR SCHEDULES		
A900	STITCH DETAILS		
ARCH PLAN L1	DOORS, WINDOWS, CABINETS, ETC.		


STRUCTURAL SHEET LIST				
Sheet Number Sheet Name				
S100	FLOOR FRAMING - L1			
S130 CEILING FRAMING - L1				
S010	FOUNDATION PLAN			
S120 EXT. WALL FRAMING ELEV - L1				
S125	EXT. WALL FRAMING ELEV - L2			
S000 GENERAL NOTES				


MEP SHEET LIST				
Sheet Number Sheet Name				
E-200	ELECTRICAL FLOOR PLANS			
M-200 MECHANICAL CRAWL PLAN				
M-201	MECHANICAL FLOOR PLANS			
P-200	PLUMBING LEGEND			
P-201 PLUMBING FLOOR PLANS				
P-202 PLUMBING ISO VIEWS				
X-200	X-200 MEP DETAILS AND SCHEDULES			
X-201 MEP DETAILS AND SCHEDULES				

KOCK CKEEK	LA PLATA COUNTY, CO
COVER PAGE	


A002




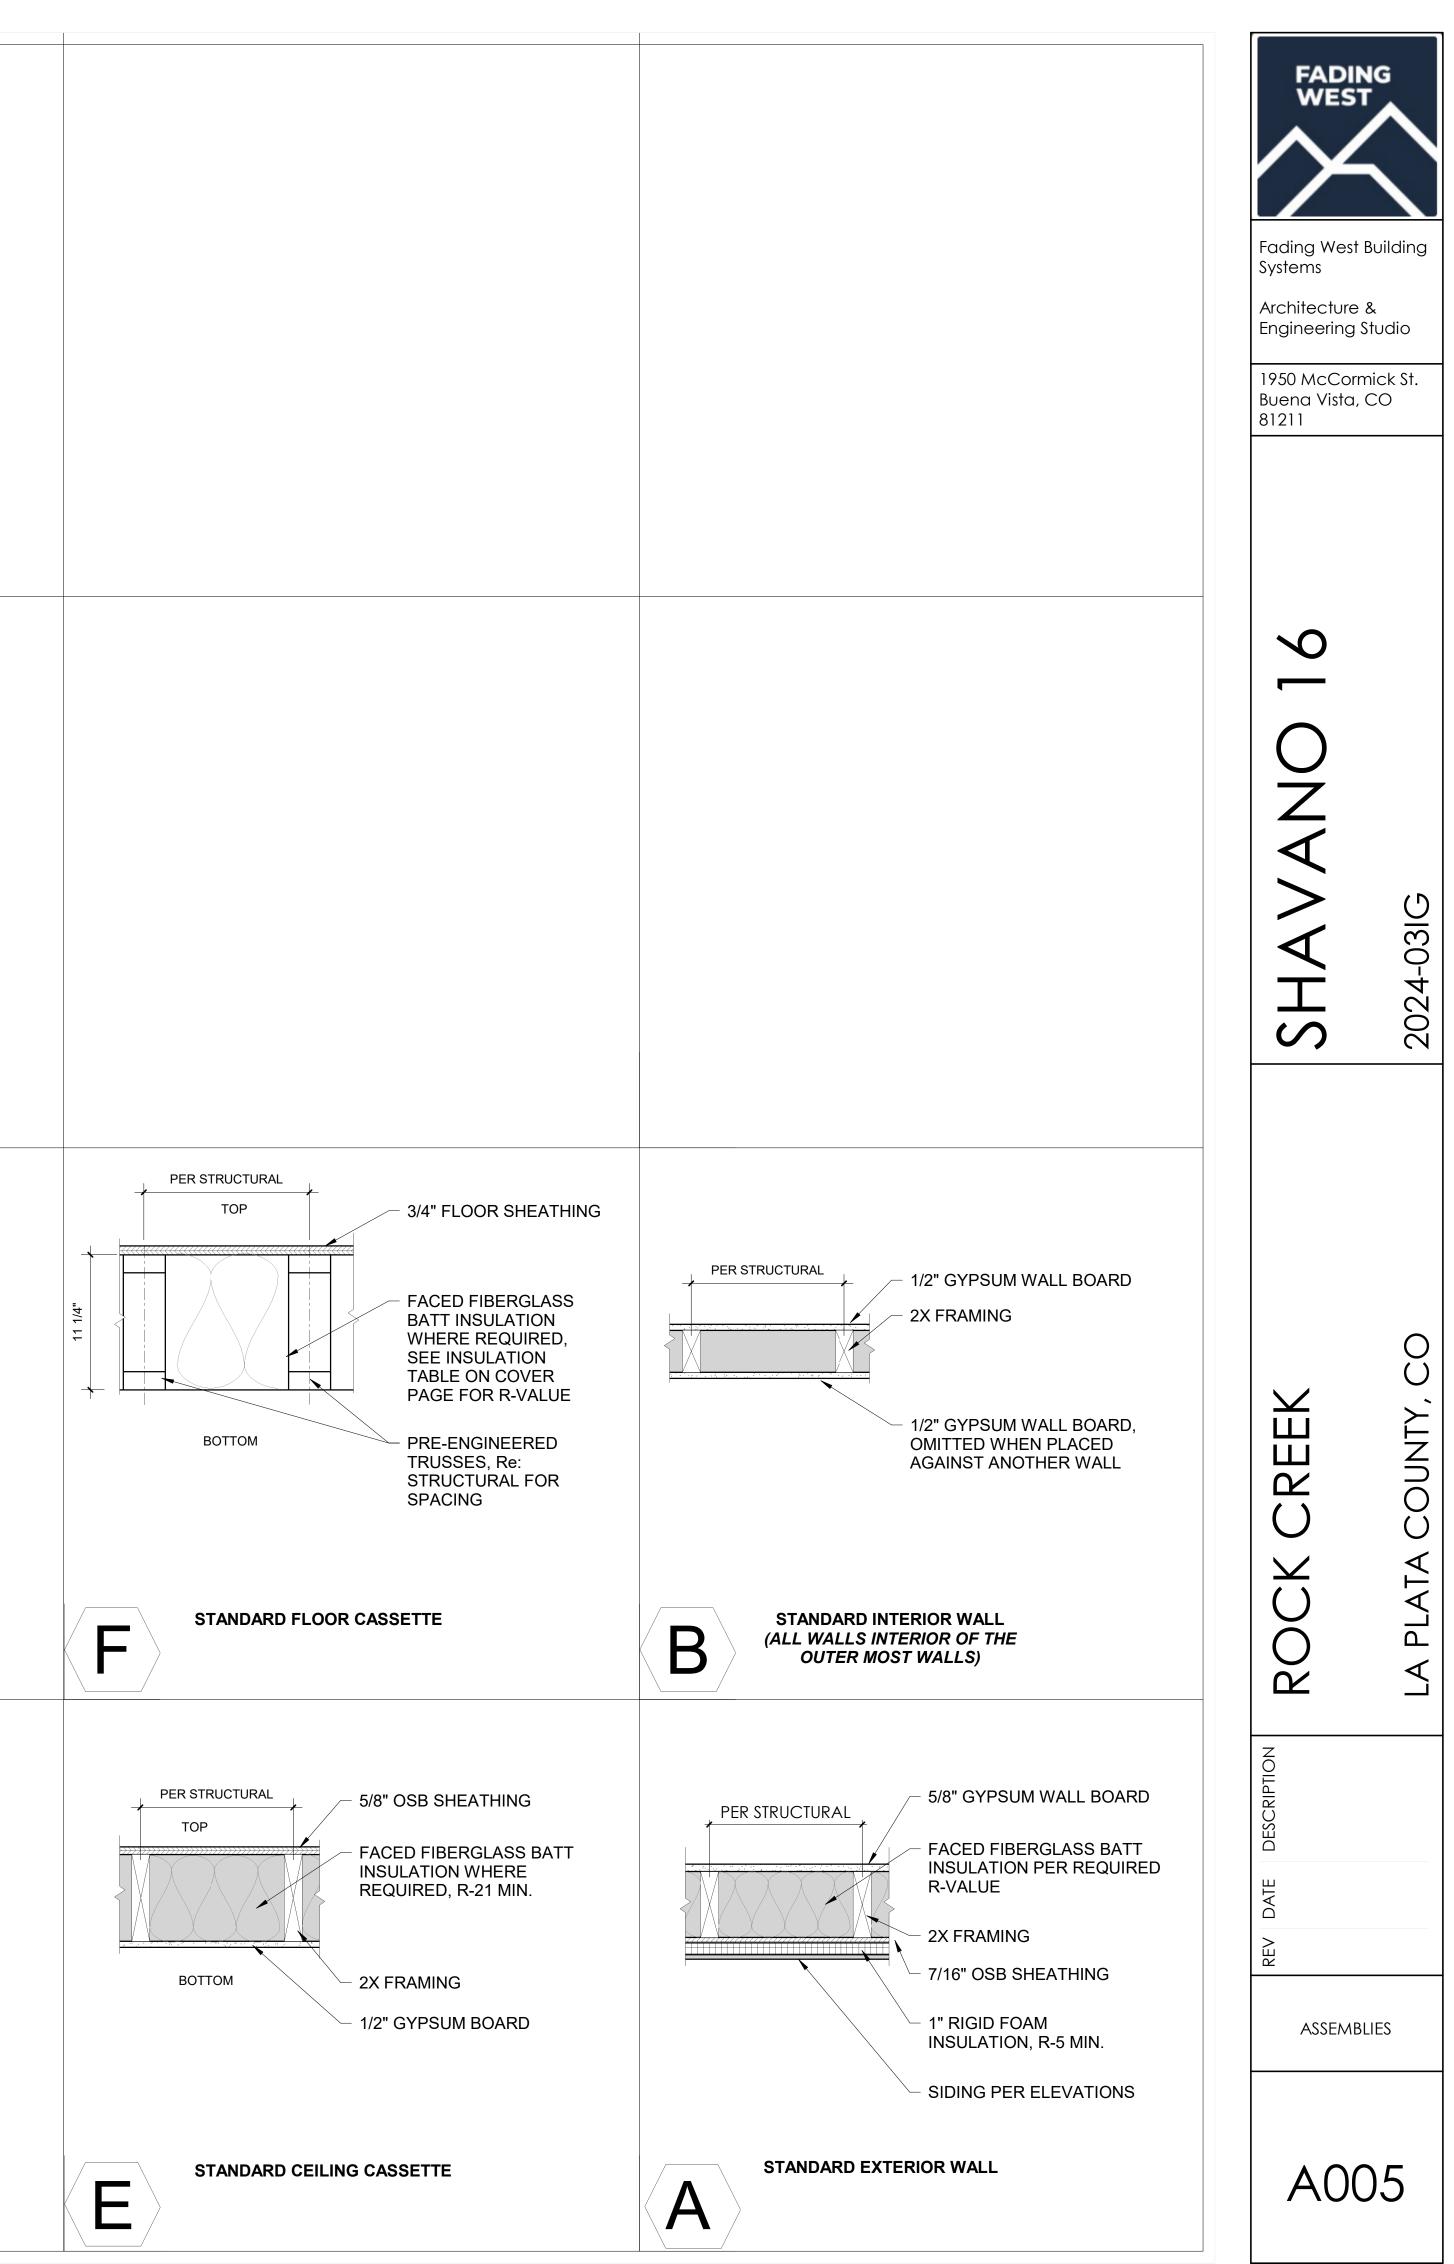


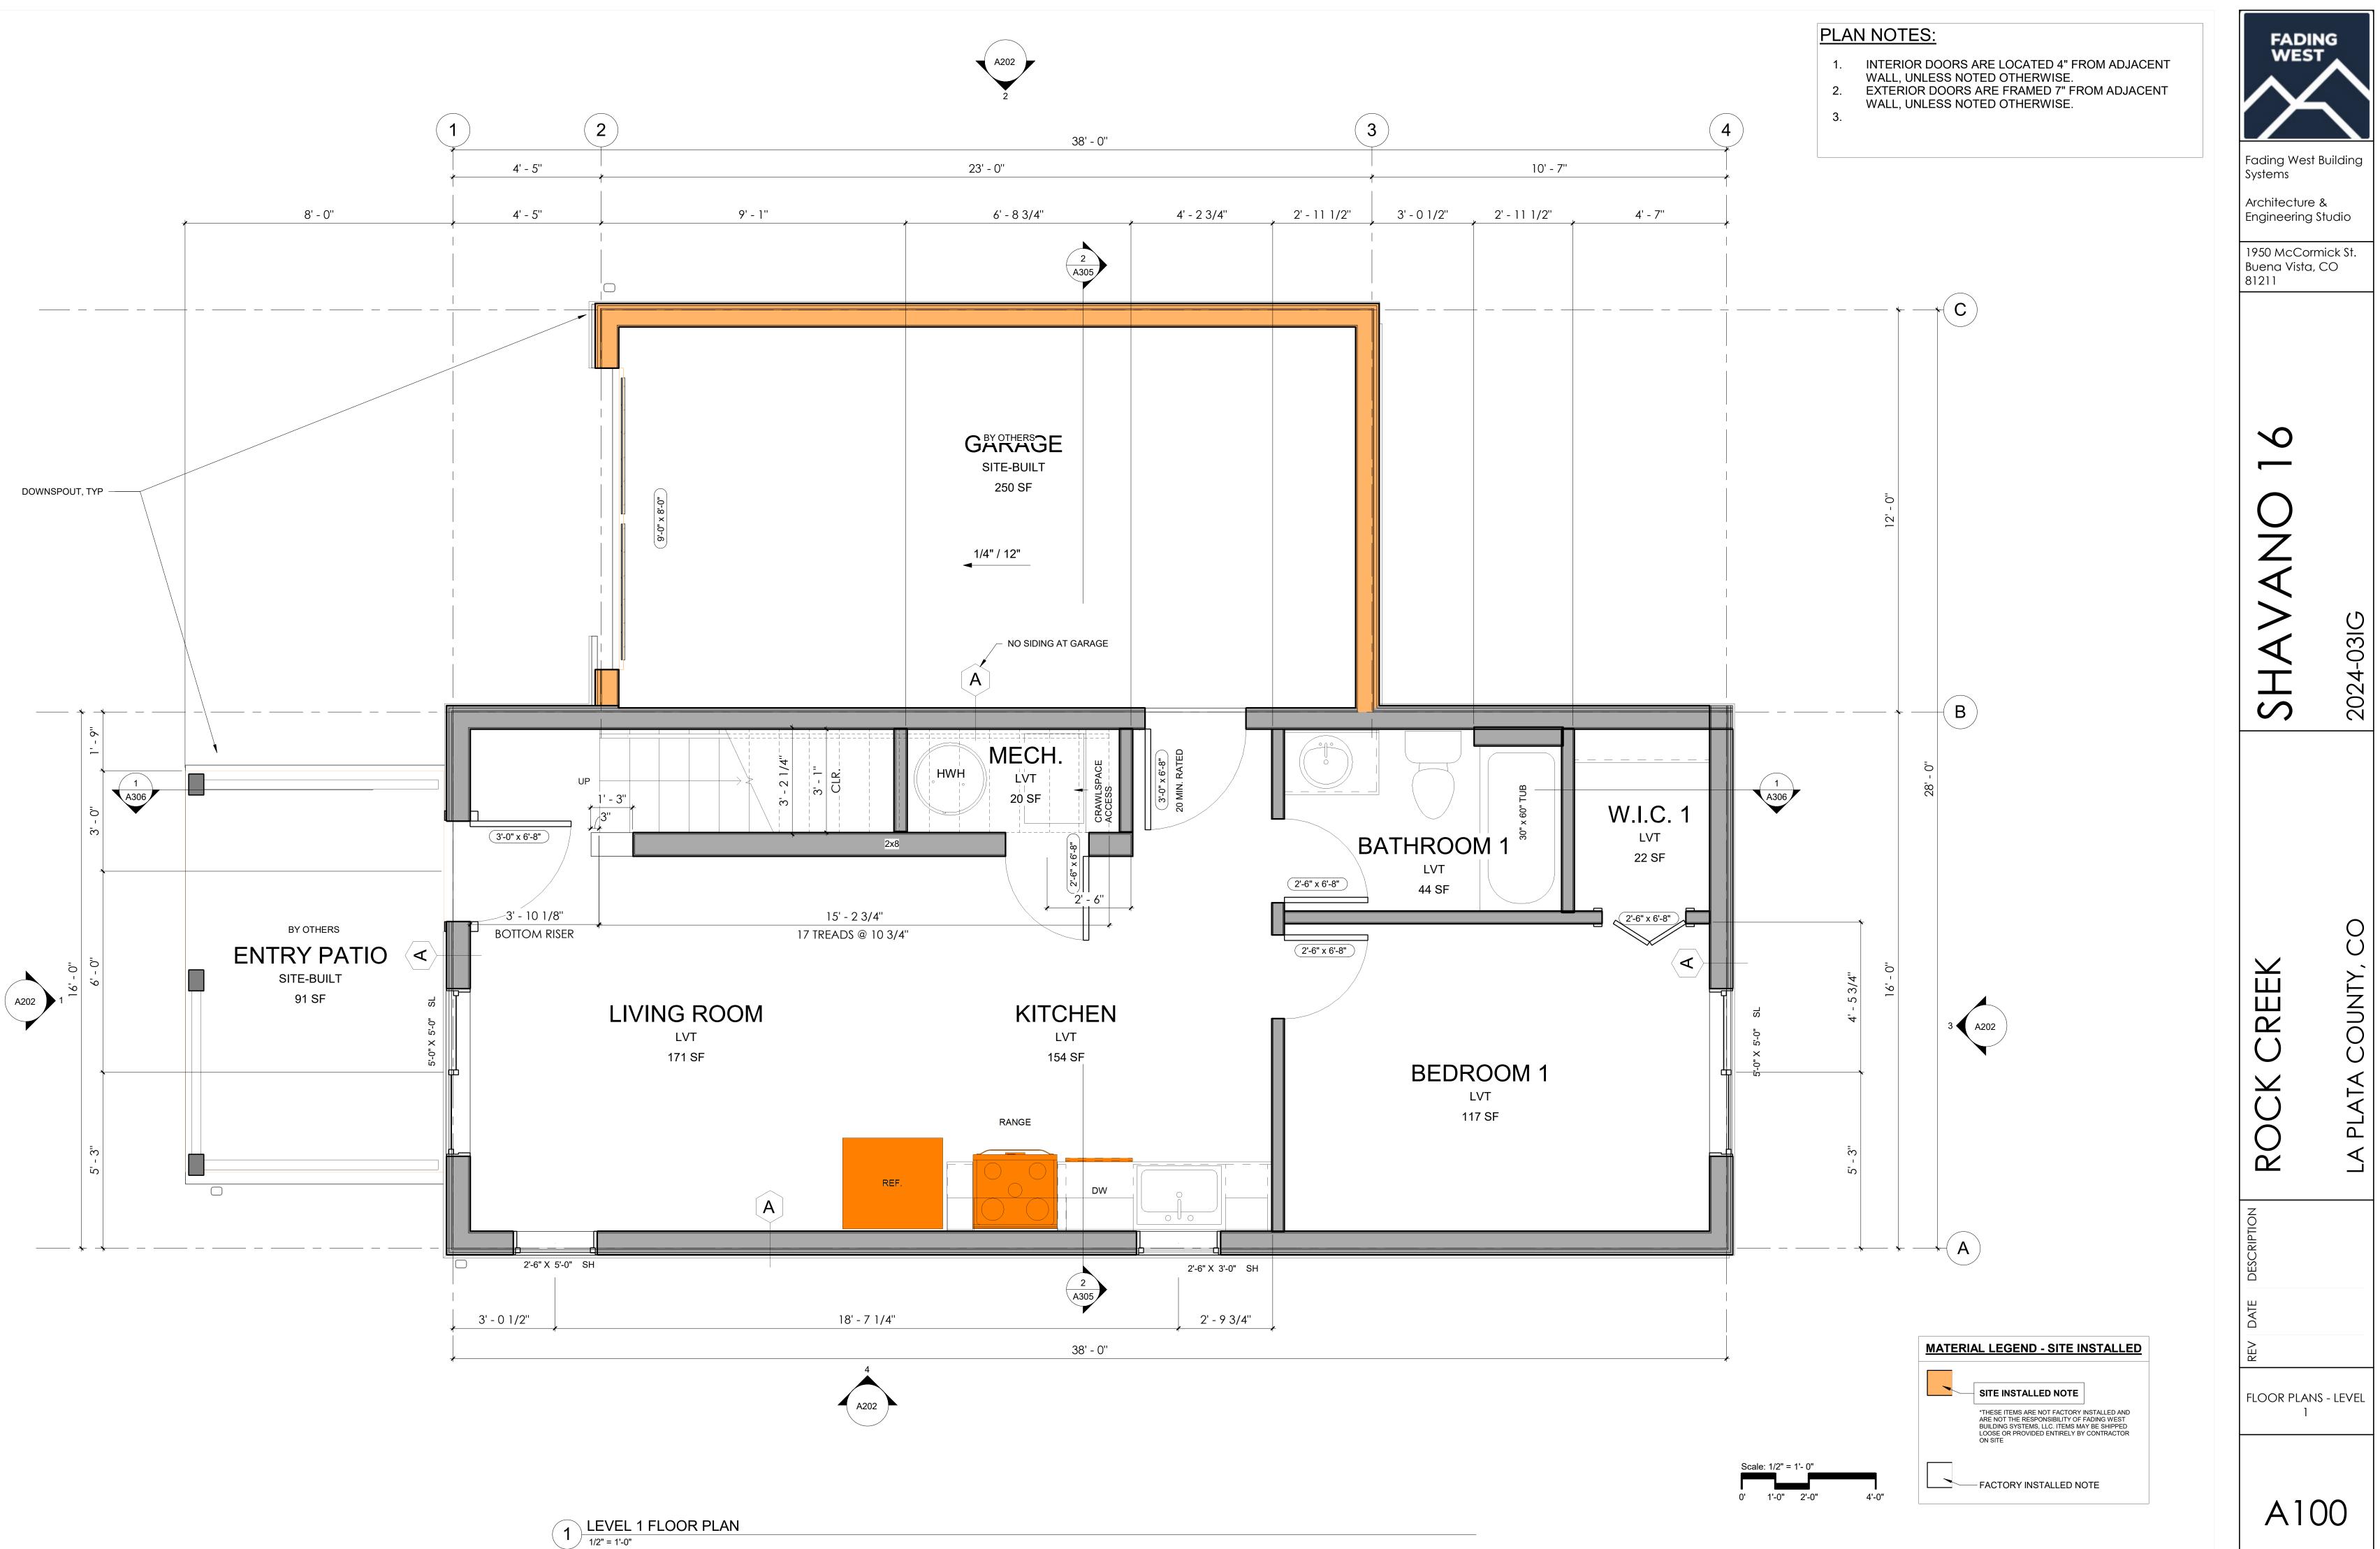




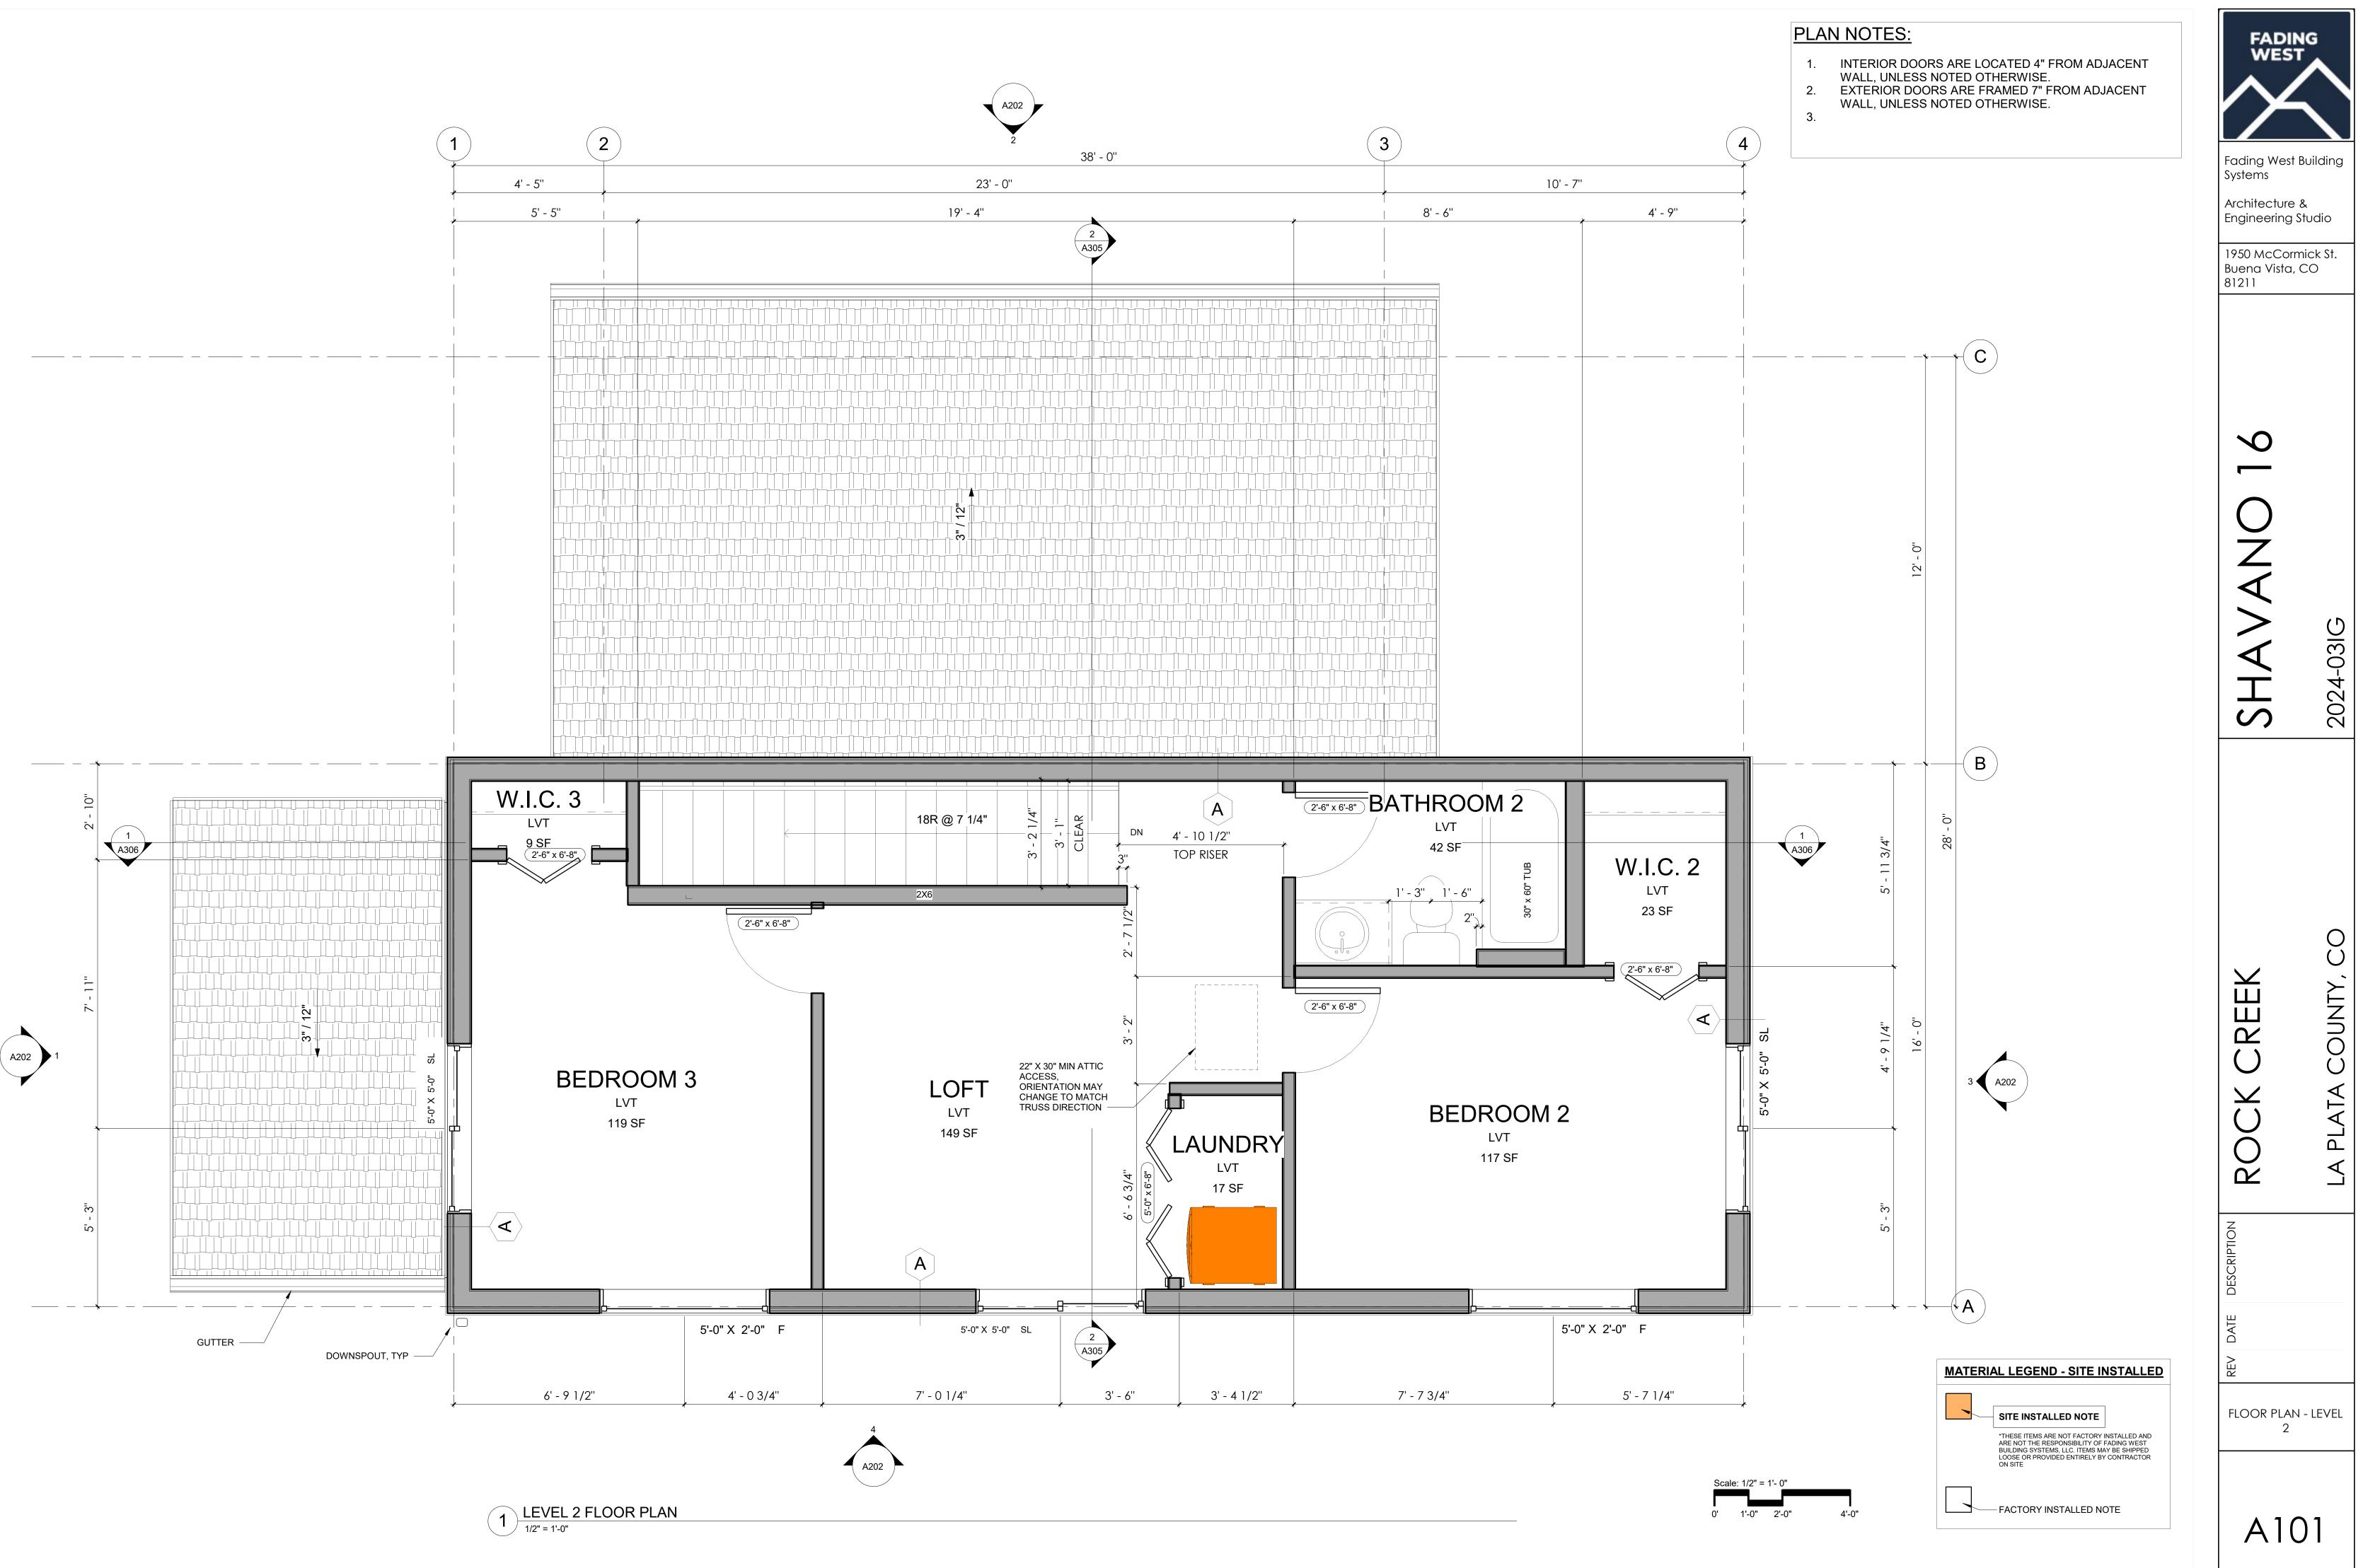

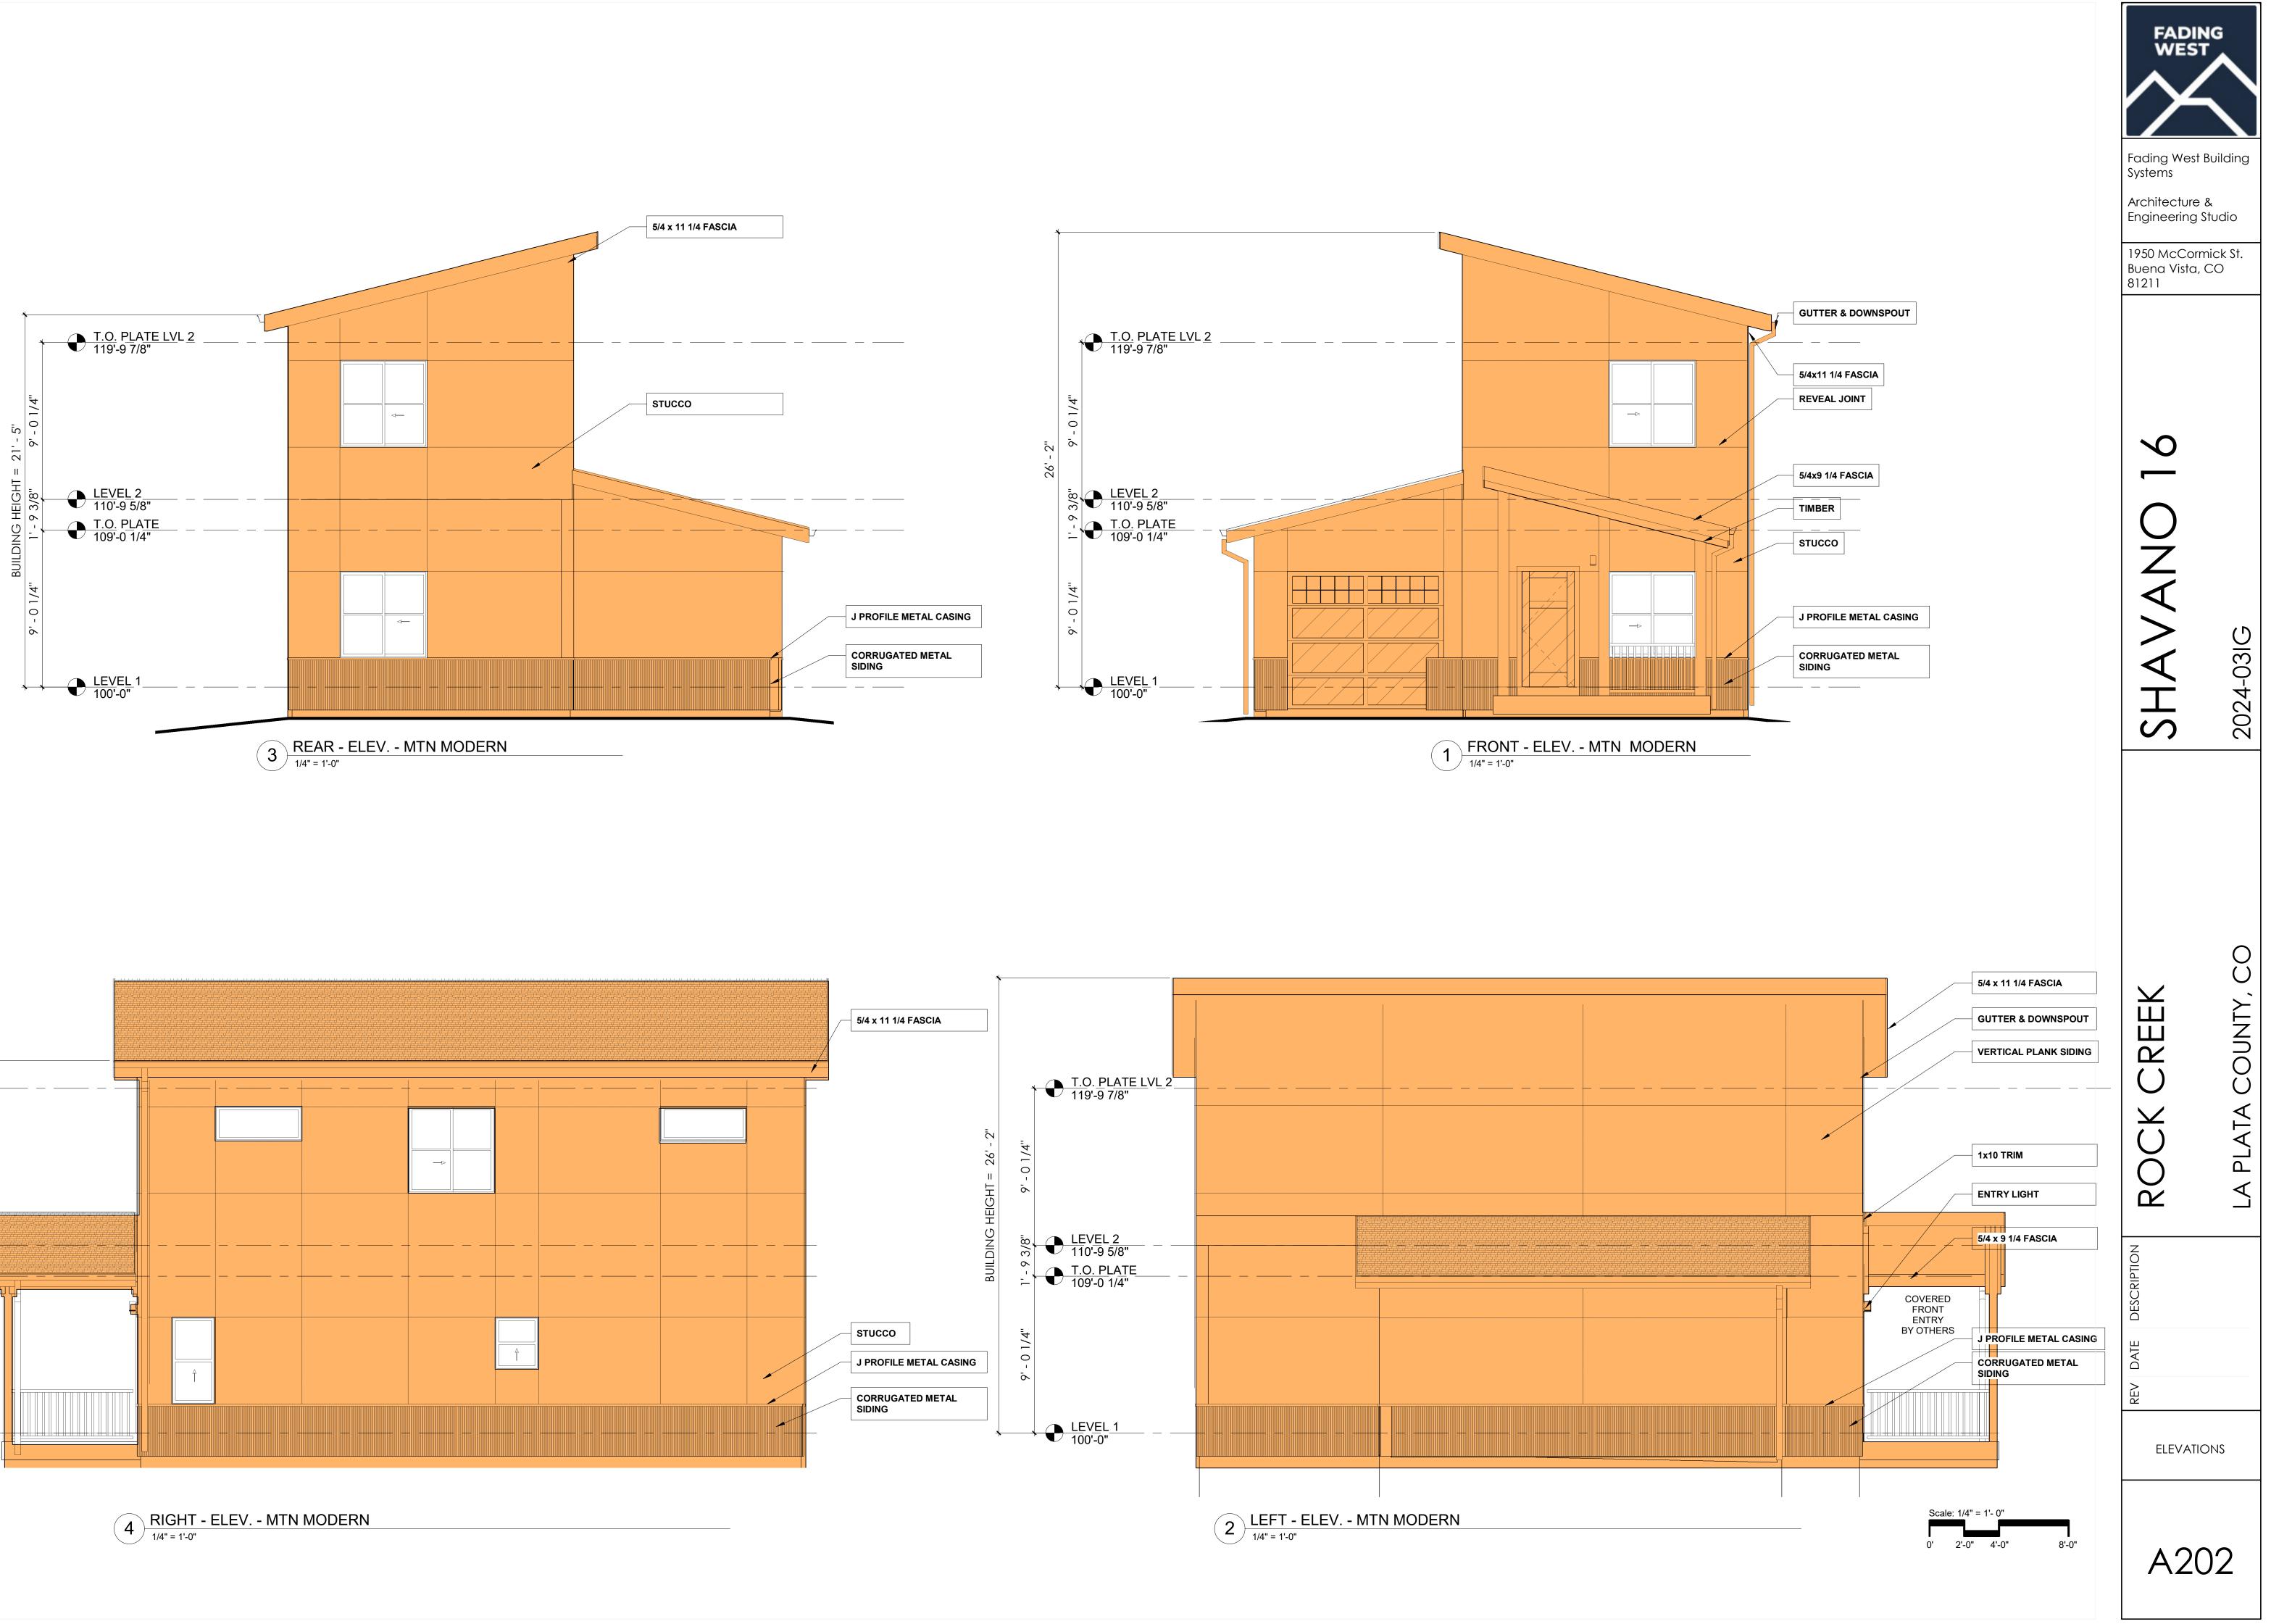


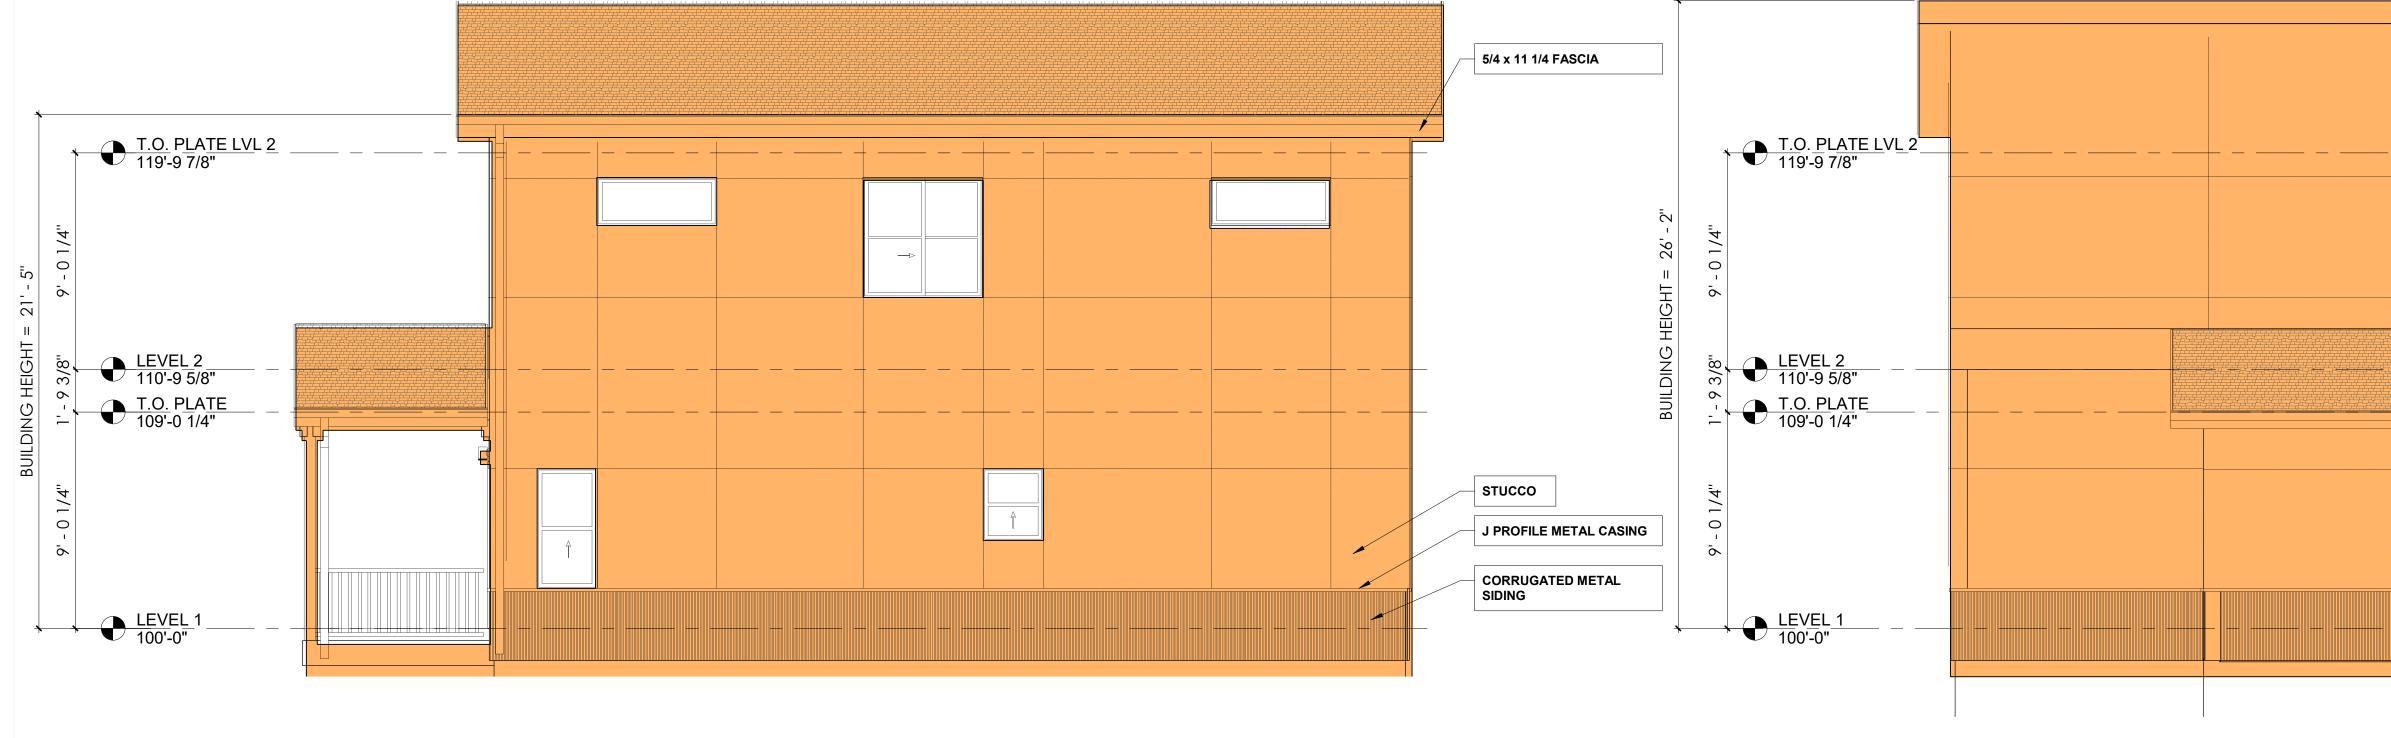


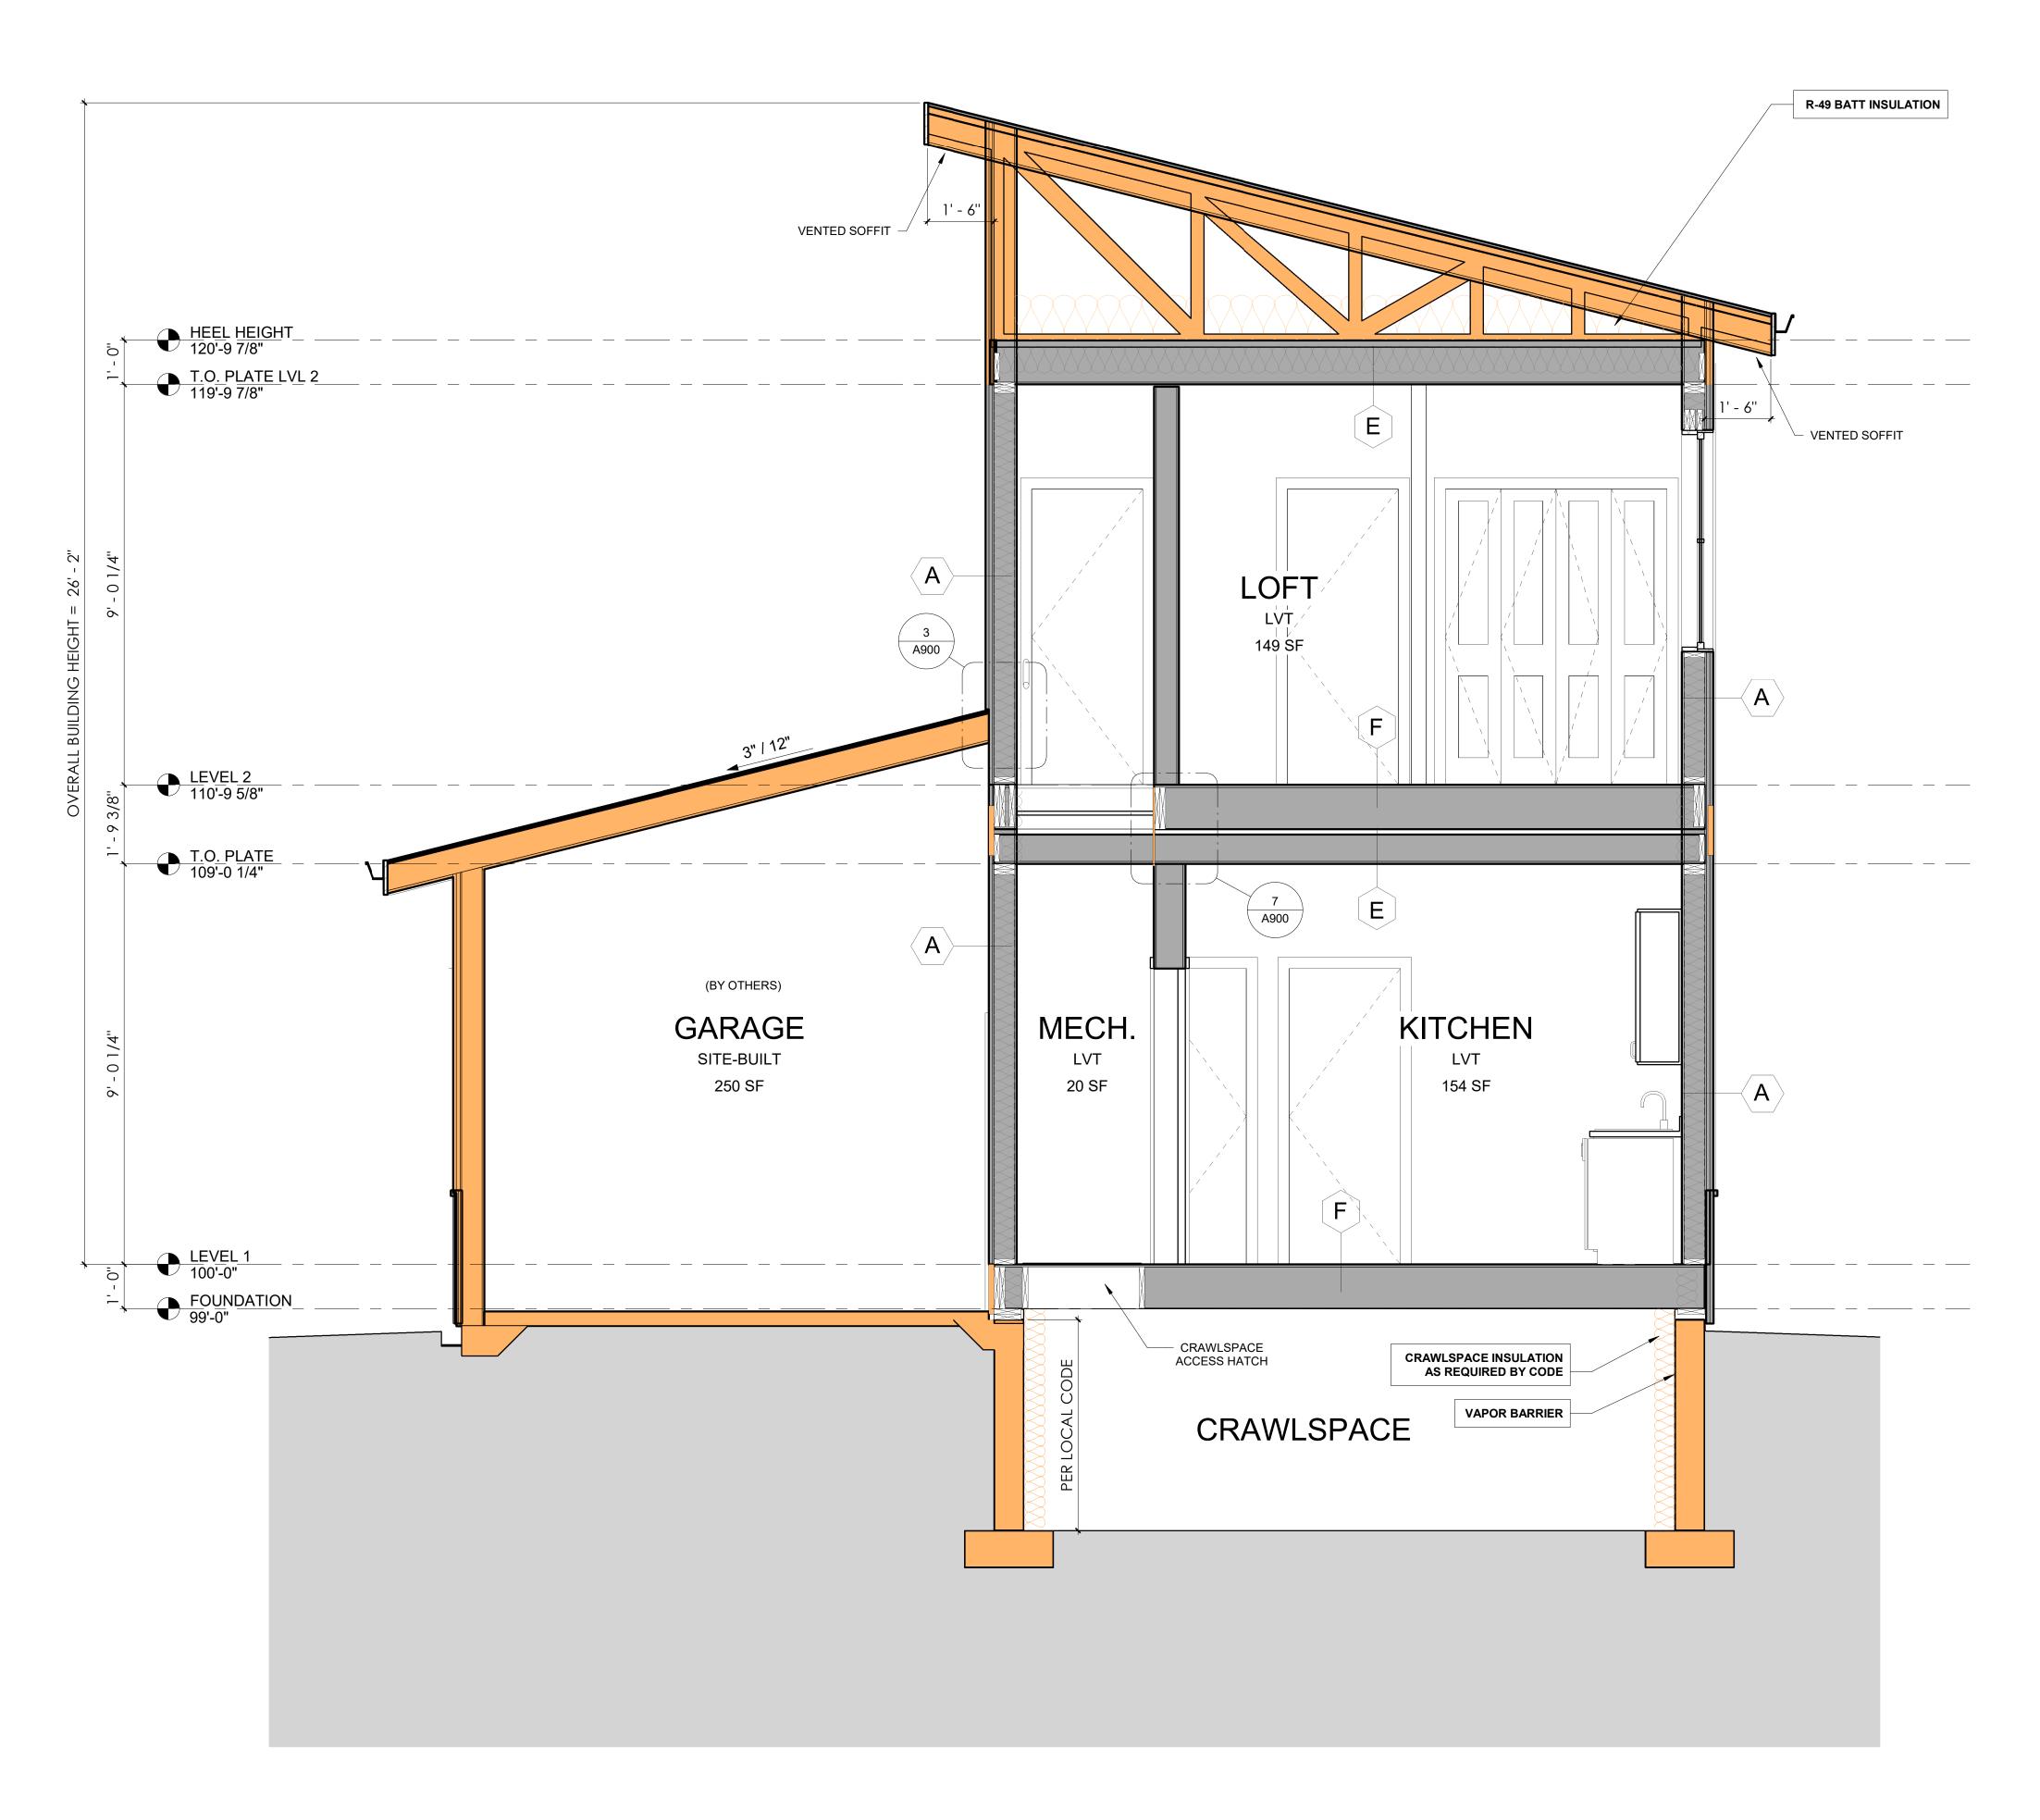


2 BLDG SECTION - CROSS SECTION 1/2" = 1'-0"


MATERIAL LEGEND - SITE INSTALLED				
	SITE INSTALLED NOTE			
	*THESE ITEMS ARE NOT FACTORY INSTALLED AND ARE NOT THE RESPONSIBILITY OF FADING WEST BUILDING SYSTEMS, LLC. ITEMS MAY BE SHIPPED LOOSE OR PROVIDED ENTIRELY BY CONTRACTOR ON SITE			
	- FACTORY INSTALLED NOTE			

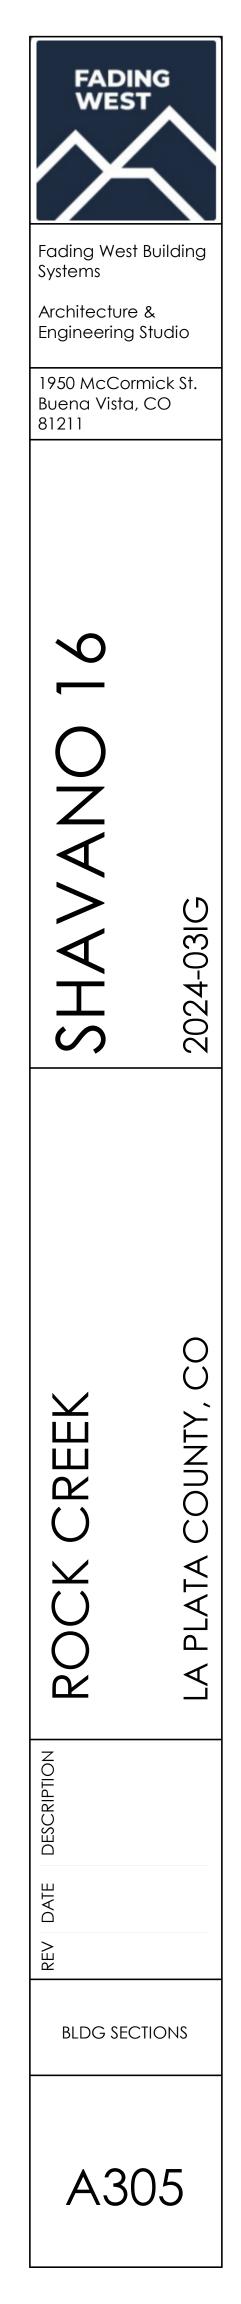

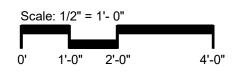


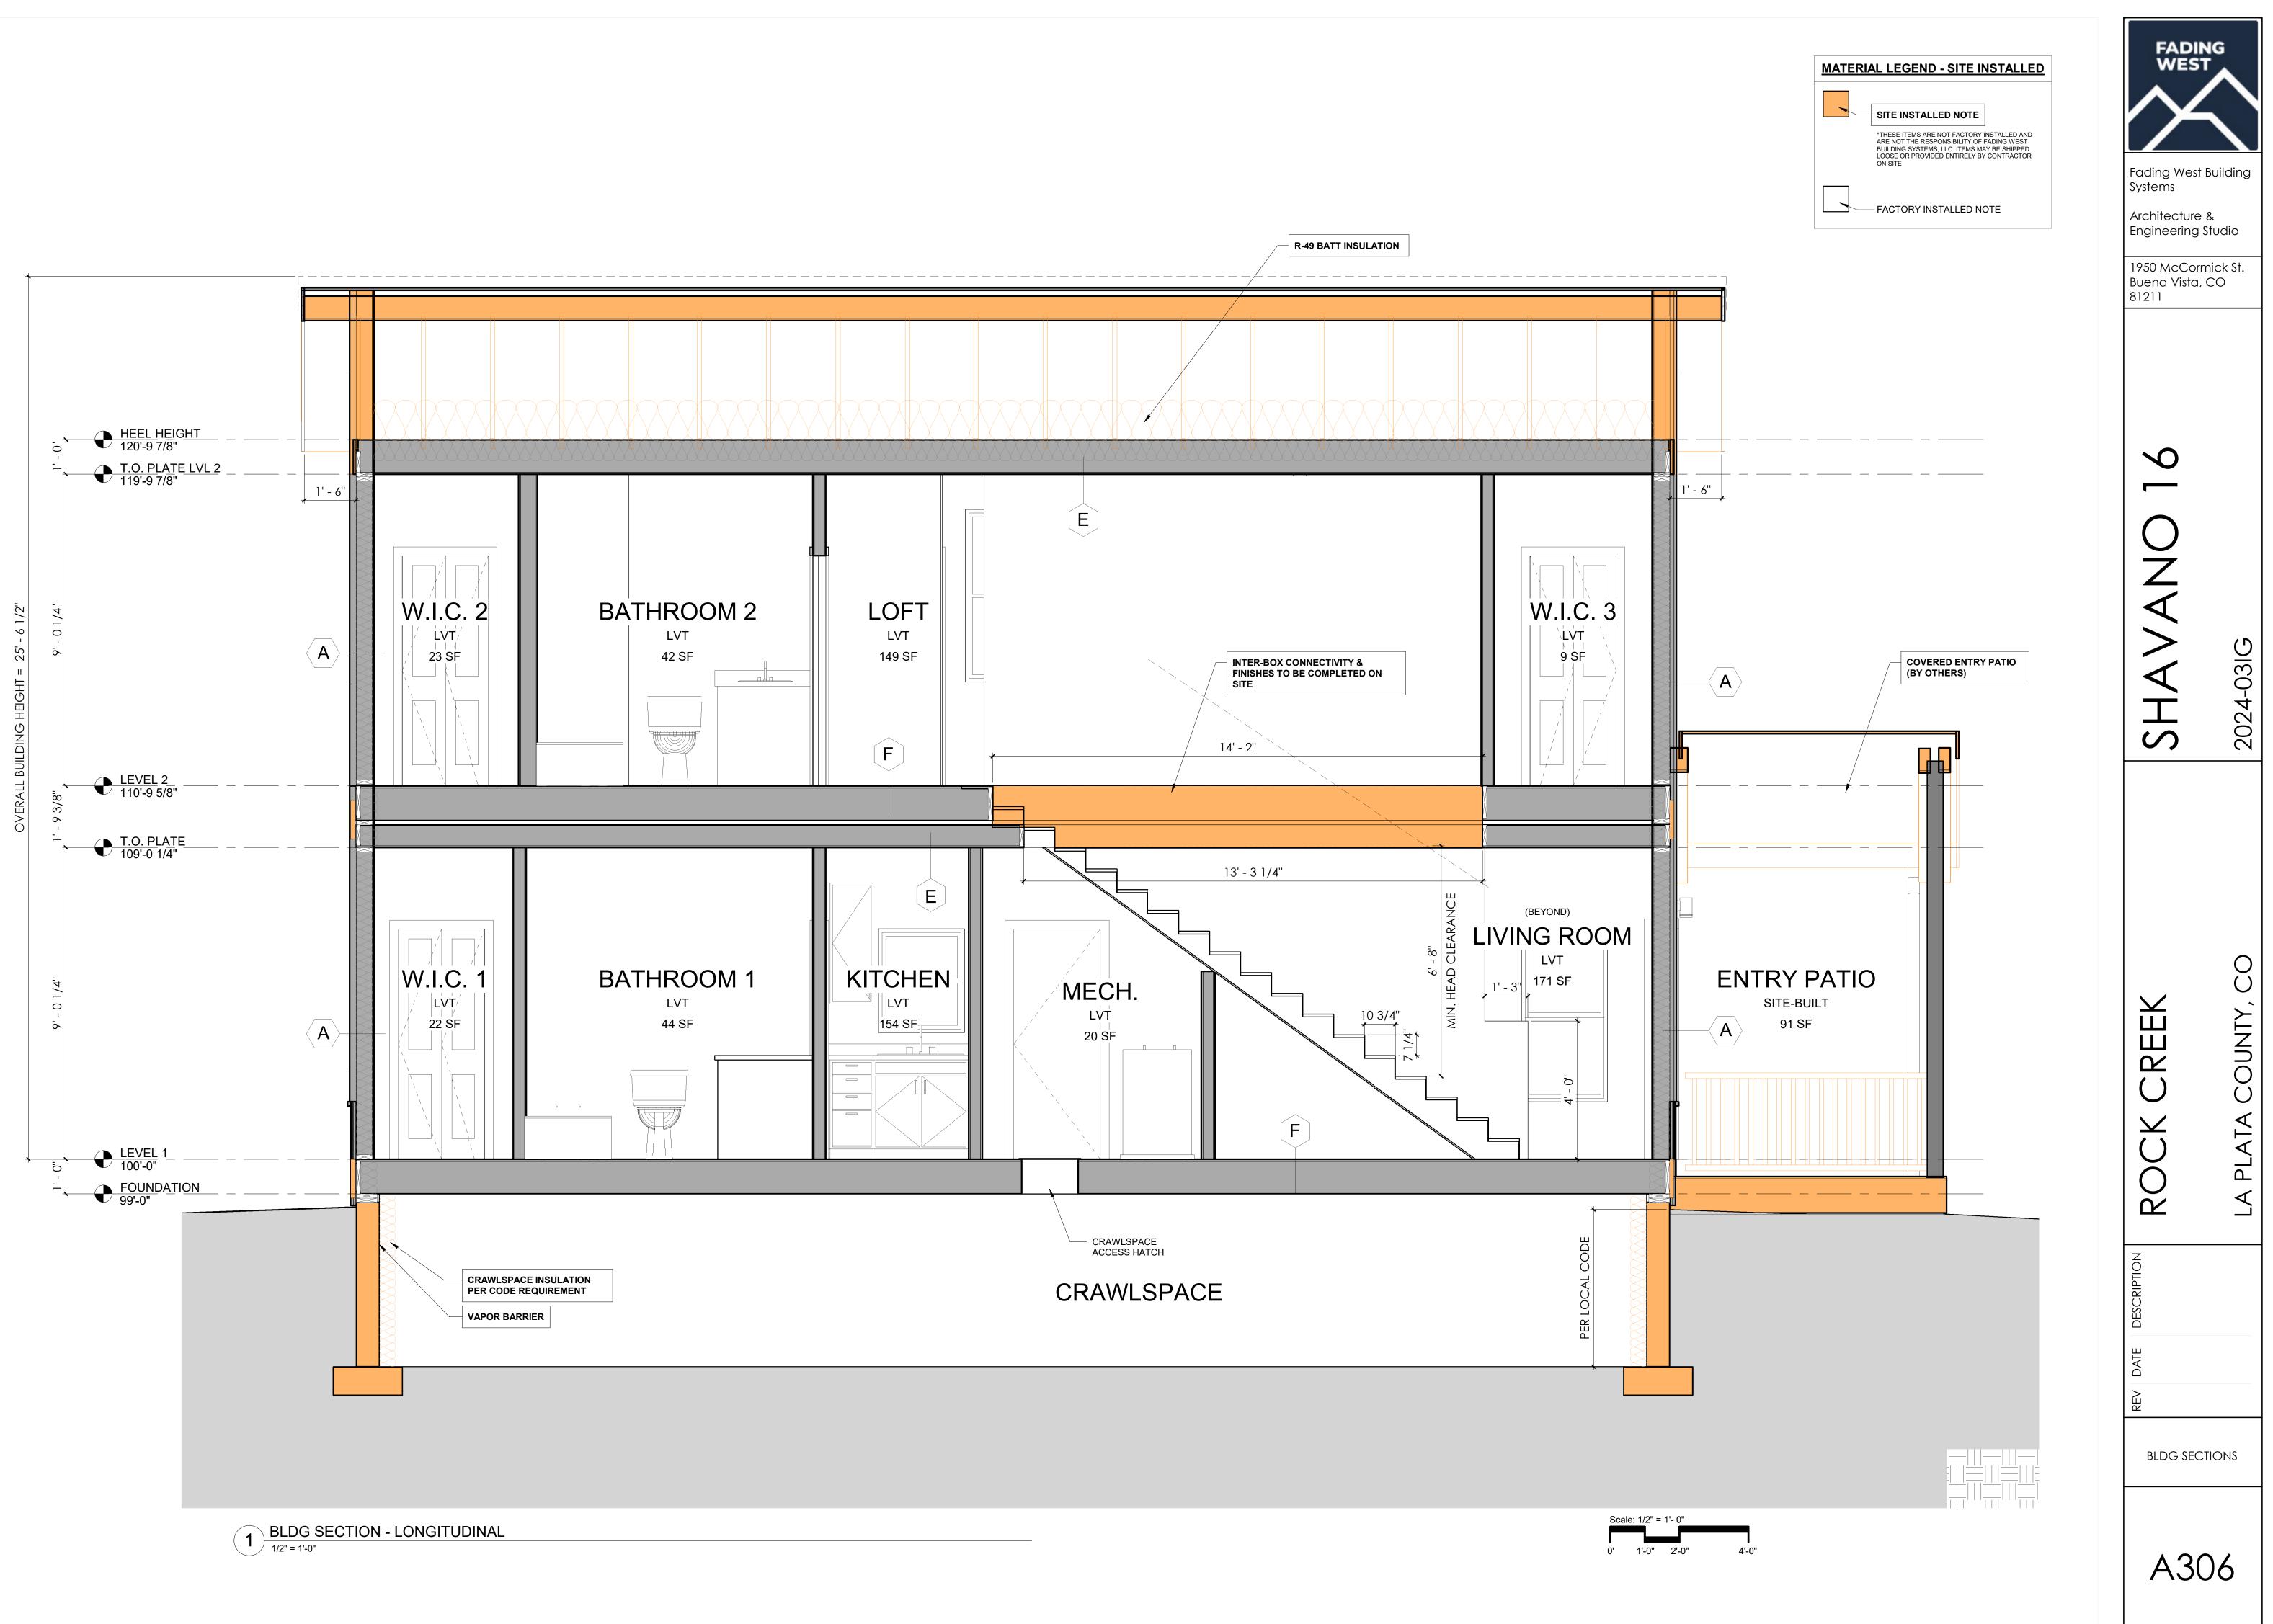

		Door Schedule		
Width	Height	Family and Type	Comments	Count
2'-6"	6'-8"	Door Bifold 2 Panel: 4-3080	2 PANEL BIFOLD	3
5'-0"	6'-8"	Door Bifold 4 Panel1: 5-6080	4 PANEL BIFOLD	1
3'-0"	6'-8"	Door Flush Adj Swing2: 3'-0"x6'-8" - 20 Min Rated	INT. SW 20 MIN-RATED	1
2'-6"	6'-8"	Door Flush Adj Swing: 2'-6"x6'-8"	INT. SW	6
3'-0"	6'-8"	Exterior Door Front Door1: 1.1-3680	(QUARTER LITE) 7 1/4" JAMB	1
9'-0"	8'-0"	Overhead-Sectional_Decorative_Door001_2346: 8' x 6'-6"	SITE-BUILT BY OTHERS	1

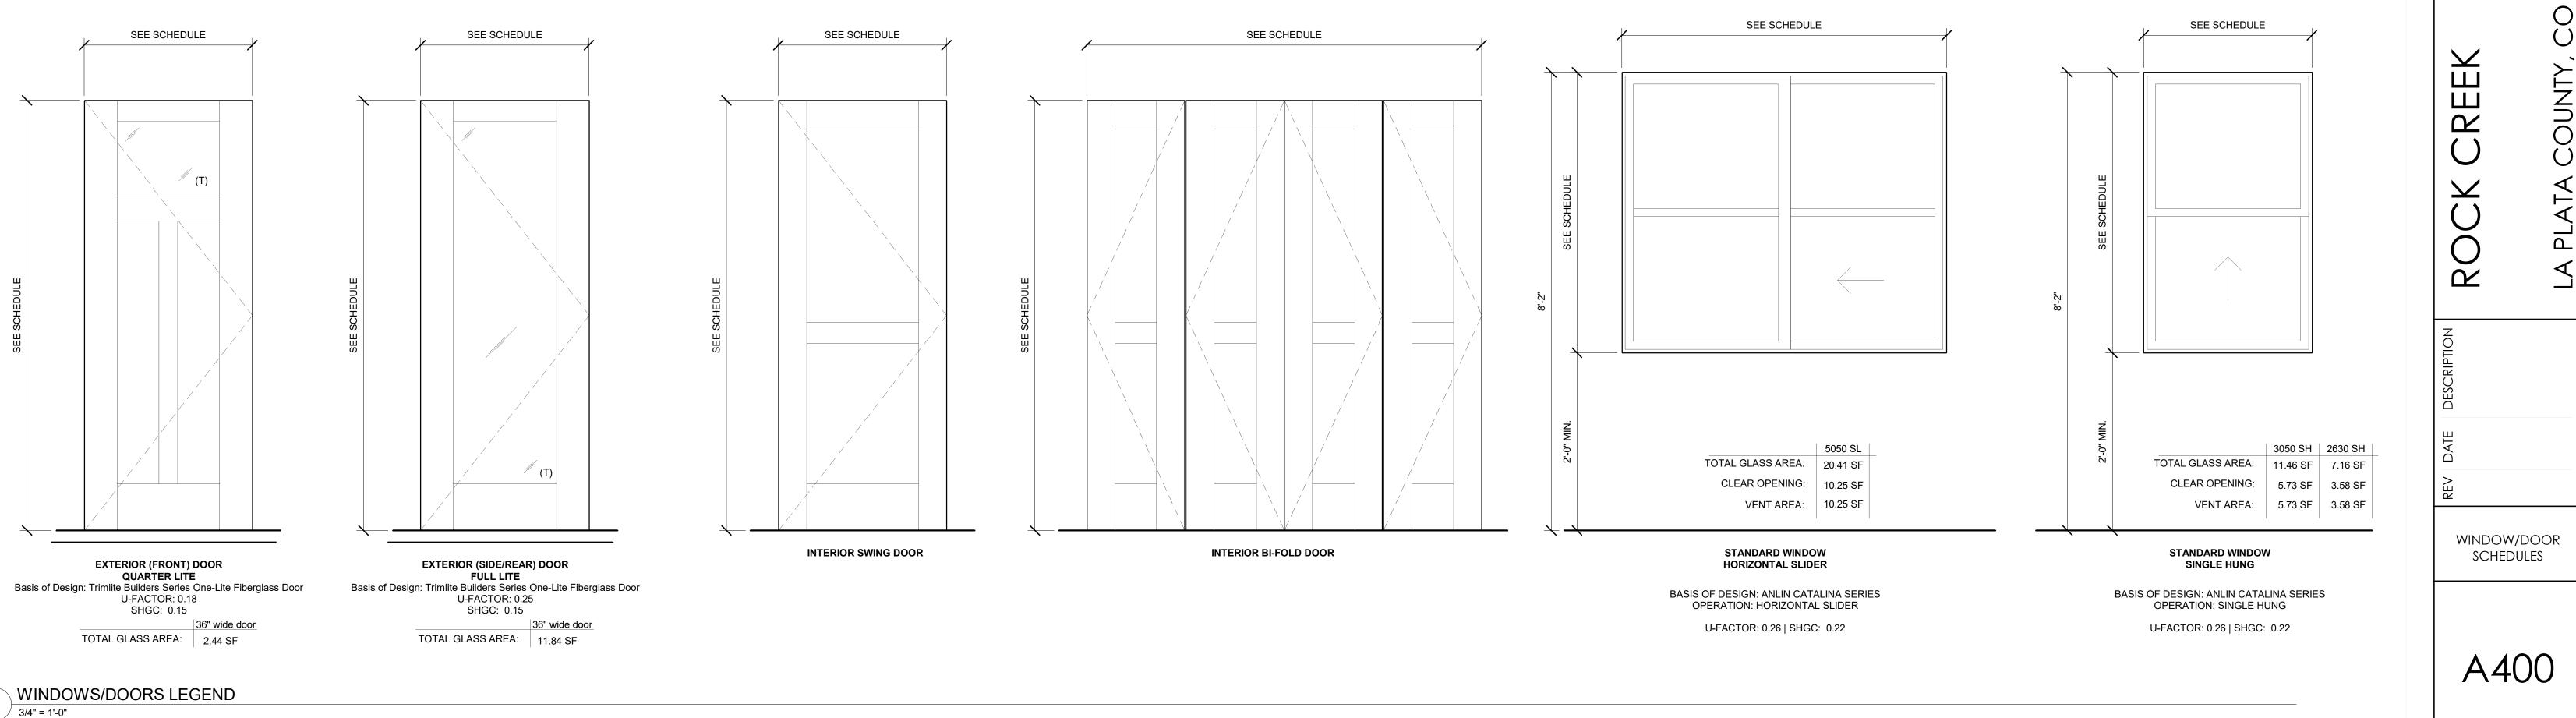

		Window Schedule	
Width	Width Height Family and Type		Count
2'-6"	3'-0"	FW - Window Single Hung2: 2'6" x 3'0"	1
2'-6"	5'-0"	FW - Window Single Hung2: 2'6" x 5'0"	1
5'-0"	2'-0"	Fixed: 5'-0"x2'-0"	2
5'-0"	5'-0"	FW - Window Slider: E-6060	5

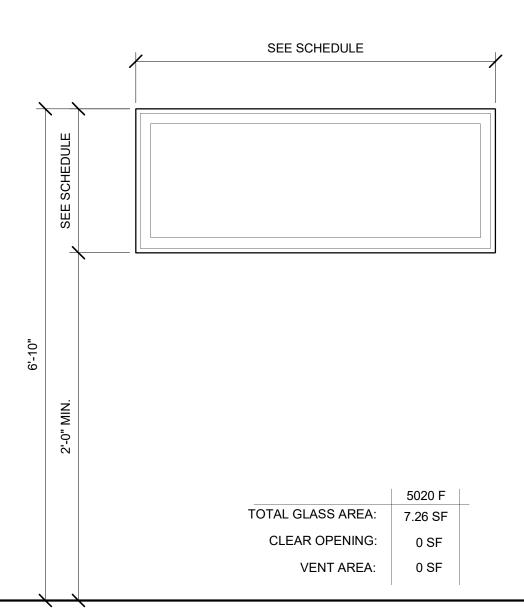

## STANDARD WINDOW FIXED

BASIS OF DESIGN: ANLIN CATALINA SERIES OPERATION: FIXED

U-FACTOR: 0.26 | SHGC: 0.22

WEST	
Fading West Bu Systems	vilding
Architecture & Engineering Stu	udio
1950 McCormic Buena Vista, Co	
81211	
SHAVANO 16	2024-03IG
ROGK CREEK	LA PLATA COUNTY, CO
REV DATE DESCRIPTION	
window/do Schedule	
A400	

