APPLICABLE COLORADO CODES

2018 INTERNATIONAL BUILDING CODE 2018 INTERNATIONAL RESIDENTIAL CODE 2018 INTERNATIONAL MECHANICAL CODE 2018 INTERNATIONAL PLUMBING CODE 2018 INTERNATIONAL FUEL GAS CODE 2018 INTERNATIONAL ENERGY CONSERVATIVE CODE 2020 NATIONAL ELECTRIC CODE 8 CCR 1302-14 ADMINISTRATIVE RULES

DESIGN CRITERIA

SITE LOCATION:

LA PLATA COUNTY, CO ELEVATION: 6500 FT LATITUDE: 37.70 N

CLIMATE ZONE: 5B

1. OCCUPANCY CLASS 2. TYPE OF CONSTRUCTION 3. GROUND SNOW LOAD 4. ROOF SNOW LOAD 5. WIND SPEED (Vult) 6. WIND SPEED (Vasd) 7. SPECIAL WIND ZONE 8. SEISMIC CATEGORY 9. WEATHERING 10. FROST LINE DEPTH 11. TERMITES 12. WINTER DESIGN TEMP **13. SUMMER DESIGN TEMP** 14. FLOOD HAZARDS

R-3 V-B 57.0 PSF 40.0 PSF 115 MPH (EXPOSURE C) 90 NO В SEVERE 32" YES 4° F 86° F DETERMINED BY LOCAL AUTHORITY HAVING JURISDICTION AND **PROJECT LOCATION**

NOTE:

THIS STRUCTURE MUST NOT BE SITED IN A LOCATION THAT EXCEEDS THE LISTED DESIGN CRITERIA. ITEMS INSTALLED ON SITE ARE NOT INSPECTED BY, OR ARE THE RESPONSIBILITY OF, THE MANUFACTURER. THIS INCLUDES, BUT IS NOT LIMITED TO, INTERIOR AND EXTERIOR LIGHT BULBS, WHOLE HOUSE VENTILATION SYSTEMS, BLOWER DOOR TESTING, COMMUNICATION TERMINAL, PLUMBING CONNECTIONS TO MAIN WASTE DRAIN, STAIR RAILINGS, AND APPLIANCES.


AN AUTOMATIC SPRINKLER SYSTEM SHALL BE INSTALLED IN ONE AND TWO FAMILY DWELLINGS AND TOWNHOUSES AS REQUIRED BY THE LOCAL JURISDICTION WHERE THE HOME WILL BE SET.

NO SITE PROVIDED BY MANUFACTURER, MINIMUM ALLOWABLE SETBACK DISTANCES TO PROPERTY LINES OR ADJACENT BUILDINGS ON THE SAME LOT SHALL BE COORDINATED BY ARCHITECT OF RECORD, OR CIVIL ENGINEER.

GENERAL NOTES

- 1. THESE DRAWINGS AND THE DESIGN SHOWN HAVE BEEN PREPARED FOR THIS SPECIFIC PROJECT AND IS THE SOLE PROPERTY OF FADING WEST BUILDING SYSTEMS, LLC. ANY REPRODUCTION, COPYING, OR USE BY OTHERS, FOR THIS PROJECT OR ANY OTHER IS PROHIBITED WITHOUT PRIOR WRITTEN CONSENT OF FADING WEST BUILDING SYSTEMS, LLC. ANY PROHIBITED USE OF THS DRAWINGS IS SUBJECT TO LEGAL ACTION.
- 2. SCOPE OF WORK NOT COMPLETED IN THE FACTORY IS DESIGNATED WITH COLOR CODIFICATION AND IS NOT A PART OF THIS SUBMITTAL PACKAGE. ITEMS TO BE INSTALLED OR CONSTRUCTE SITE ARE THE RESPONSIBILITY OF THE GENERAL CONTRACTOR OR OWNER.
- 3. THESE PLANS SHOW ONE ORIENTATION OF THE PROPOSED DESIGN. UNITS MAY BE MIRRORE SITE TO ACCOMODATE SITE PLANS AS NECESSARY. IN THE CASE WHERE THIS DESIGN IS MIRRORED, ALL DIMENSIONS, LOCATIONS, AND COMPONENTS SHALL BE THE SAME RELATIVE THE NEW ORIENTATION OF THE PLAN AND ELEVATIONS.
- 4. PROJECTS DESIGNED TO NEWER CODES THAN THE 2018 IRC/IBC SHALL COMPLY WITH BOTH AND NEWER CODE, ADHERING TO THE STRICTER OF THE TWO WHERE APPLICABLE.

IGNACIO - ROCK CREE ANTERO MASTER UNIT SET

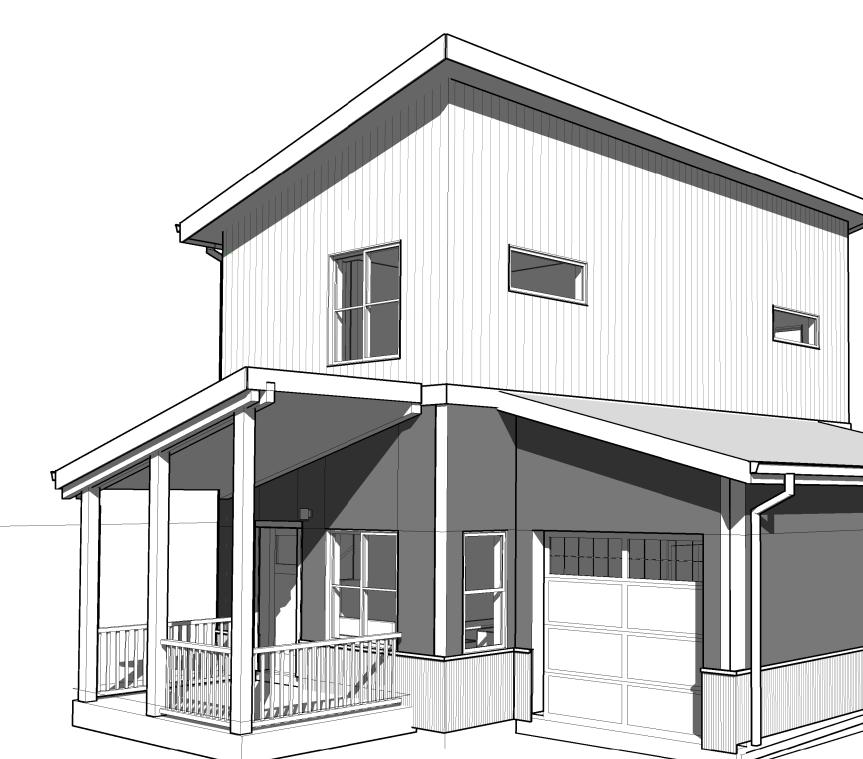

INSULATION R-VALUES:

PER 2018 IECC TABLE R402.1.3


TABLE R402.1.2 INSULATION AND FENESTRATION REQUIREMENTS BY COMPONENT^a


	CLIMATE ZONE	FENESTRATION U-FACTOR ^b	SKYLIGHT ^b <i>U-</i> FACTOR	GLAZED FENESTRATION SHGC ^{b, e}	CEILING <i>R</i> -VALUE	WOOD FRAME WALL <i>R</i> -VALUE	MASS WALL <i>R</i> -VALUE ⁱ	FLOOR <i>R</i> -VALUE	BASEMENT ^C WALL <i>R</i> -VALUE
ED ON	1	NR	0.75	0.25	30	13	3/4	13	0
	2	0.40	0.65	0.25	38	13	4/6	13	0
ED ON	3	0.32	0.55	0.25	38	20 or 13+5 ^h	8/13	19	5/13 ^f
	4 except Marine	0.32	0.55	0.40	49	20 or 13+5 ^h	8/13	19	10/13
ΤΟ	5 and Marine 4	0.30	0.55	NR	49	20 or 13+5 ^h	13/17	30 ^g	15/19
12018	6	0.30	0.55	NR	49	20+5 ^h or 13+10 ^h	15/20	30 ^g	15/19
	7 and 8	0.30	0.55	NR	49	20+5 ^h or 13+10 ^h	19/21	38 ^g	15/19

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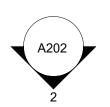
K		FADING WESTFading West Building SystemsArchitecture & Engineering Studio1950 McCormick St. Buena Vista, CO 81211
		ANTERO 16 2024-03_IG
	ARCH SHEETS Sheet # Sheet Name A002 COVER PAGE A005 ASSEMBLIES A100 FLOOR PLANS - LEVEL 1 A101 FLOOR PLAN - LEVEL 2 A202 ELEVATIONS A305 BLDG SECTIONS A306 BLDG SECTIONS A400 WINDOW/DOOR SCHEDULES A900 STITCH DETAILS	Ignacio, CO
$\begin{array}{c c c c c c c c c c c c c c c c c c c $	MEP SHEETS Sheet # Sheet Name M-1 L1 MECHANICAL M-2 L2 MECHANICAL E-1 L1 ELECTRICAL CEILING LAYOUT E-2 L1 ELECTRICAL FLOOR LAYOUT E-3 L2 ELECTRICAL CEILING LAYOUT E-4 L2 ELECTRICAL FLOOR LAYOUT P-1 PLUMBING DWV - FLOOR LAYOUT	DATE DESCRIPTION
10, 4 ft 15/19 10, 4 ft 15/19	P-3 L1 PLUMBING ISO W/WALLS P-4 L1 PLUMBING ISO W/ WALLS P-5 L1 PLUMBING CEILING LAYOUT P-6 L1 PLUMBING CEILING LAYOUT	A002

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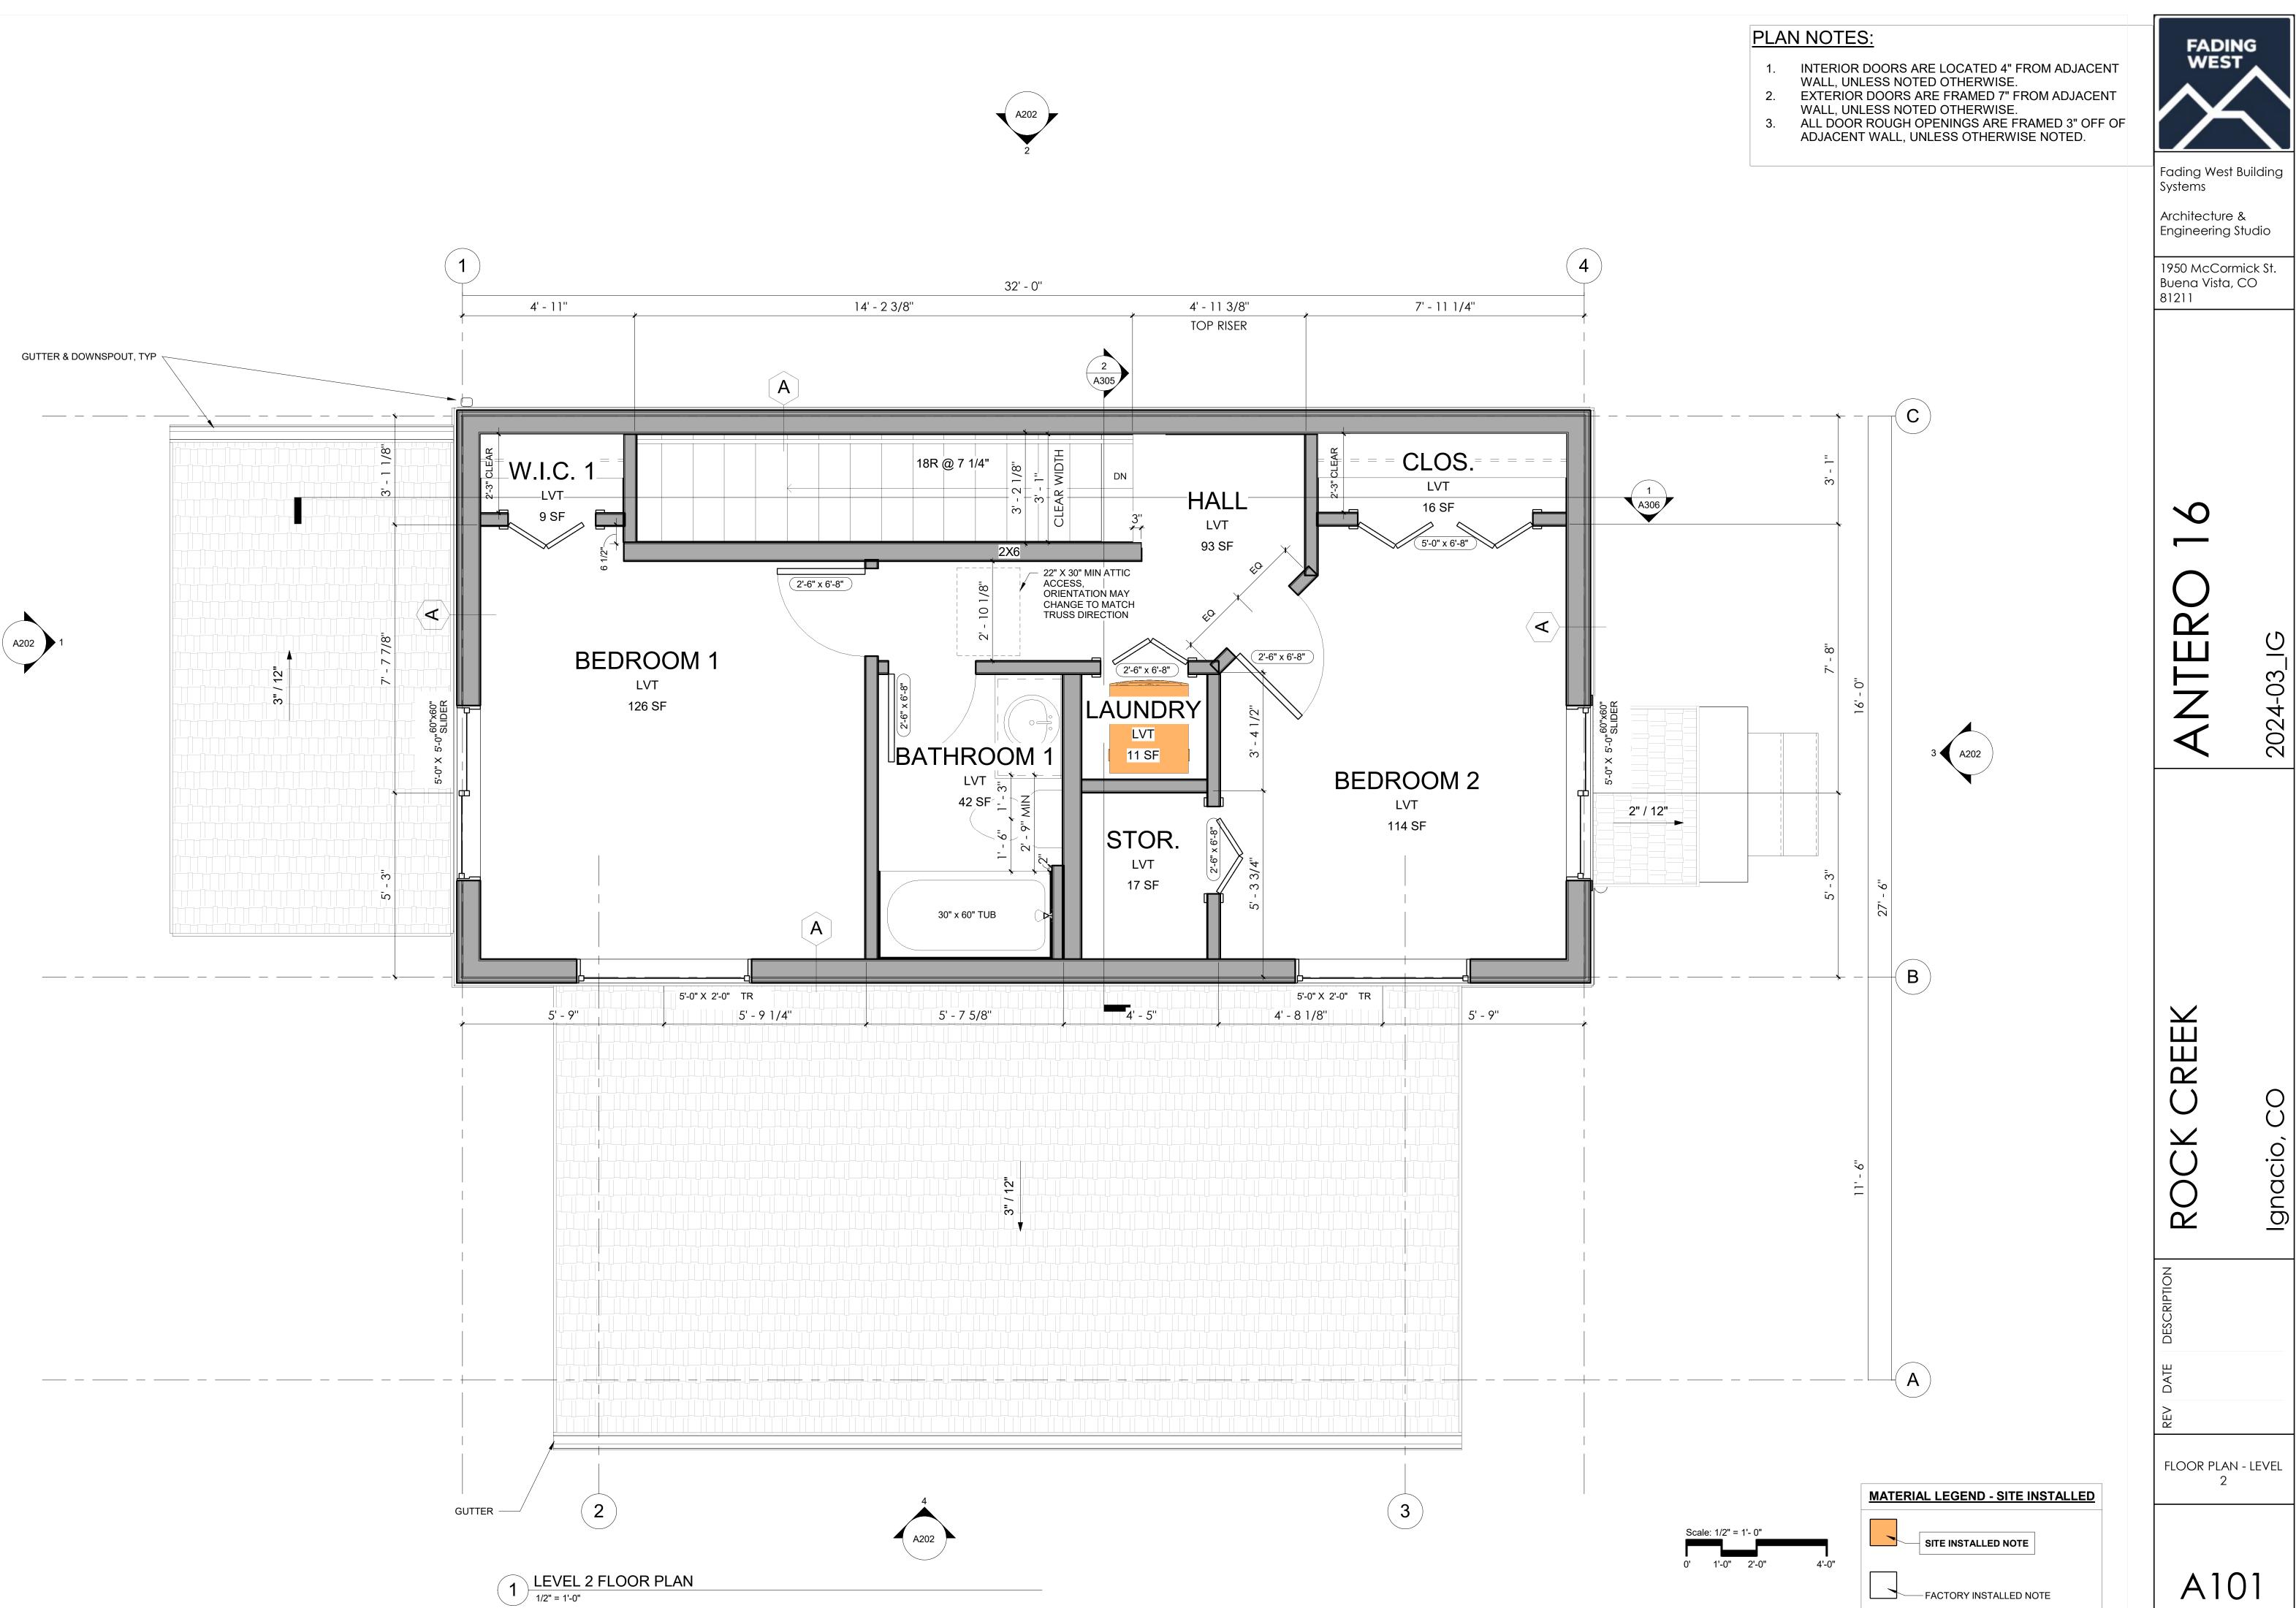



1 <u>LEVEL 1 FLOOR PLAN</u> 1/2" = 1'-0"

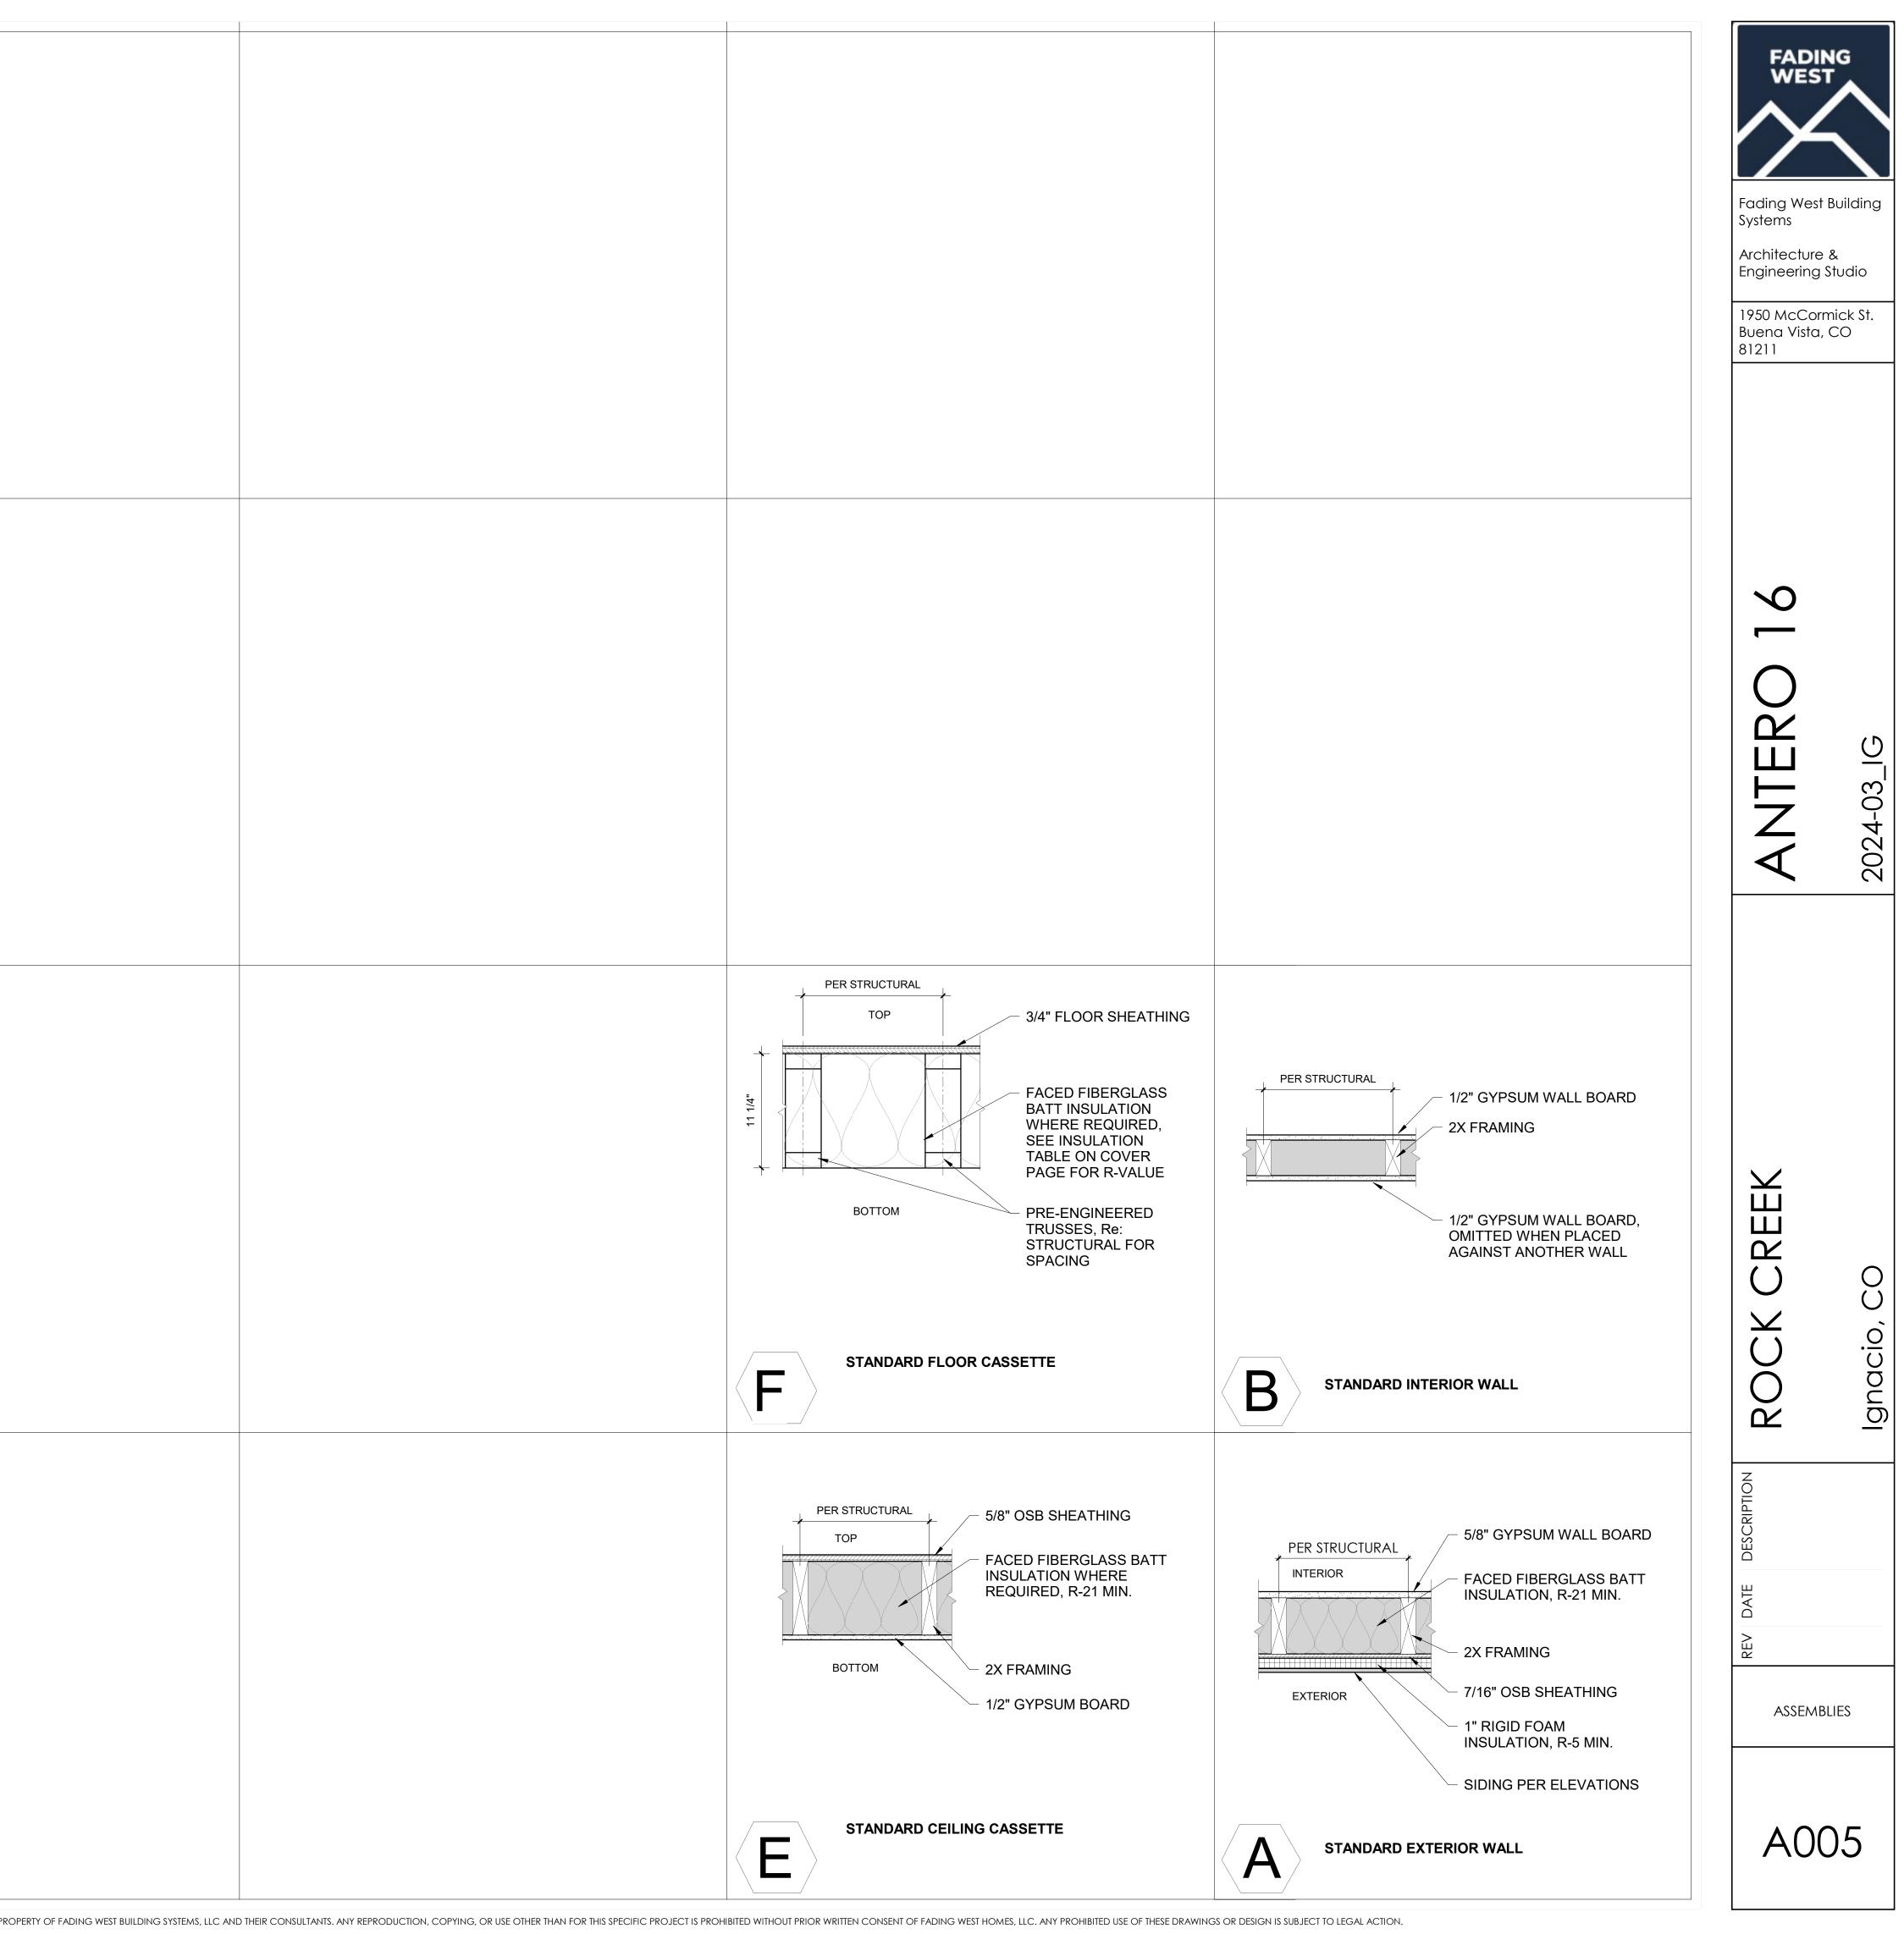


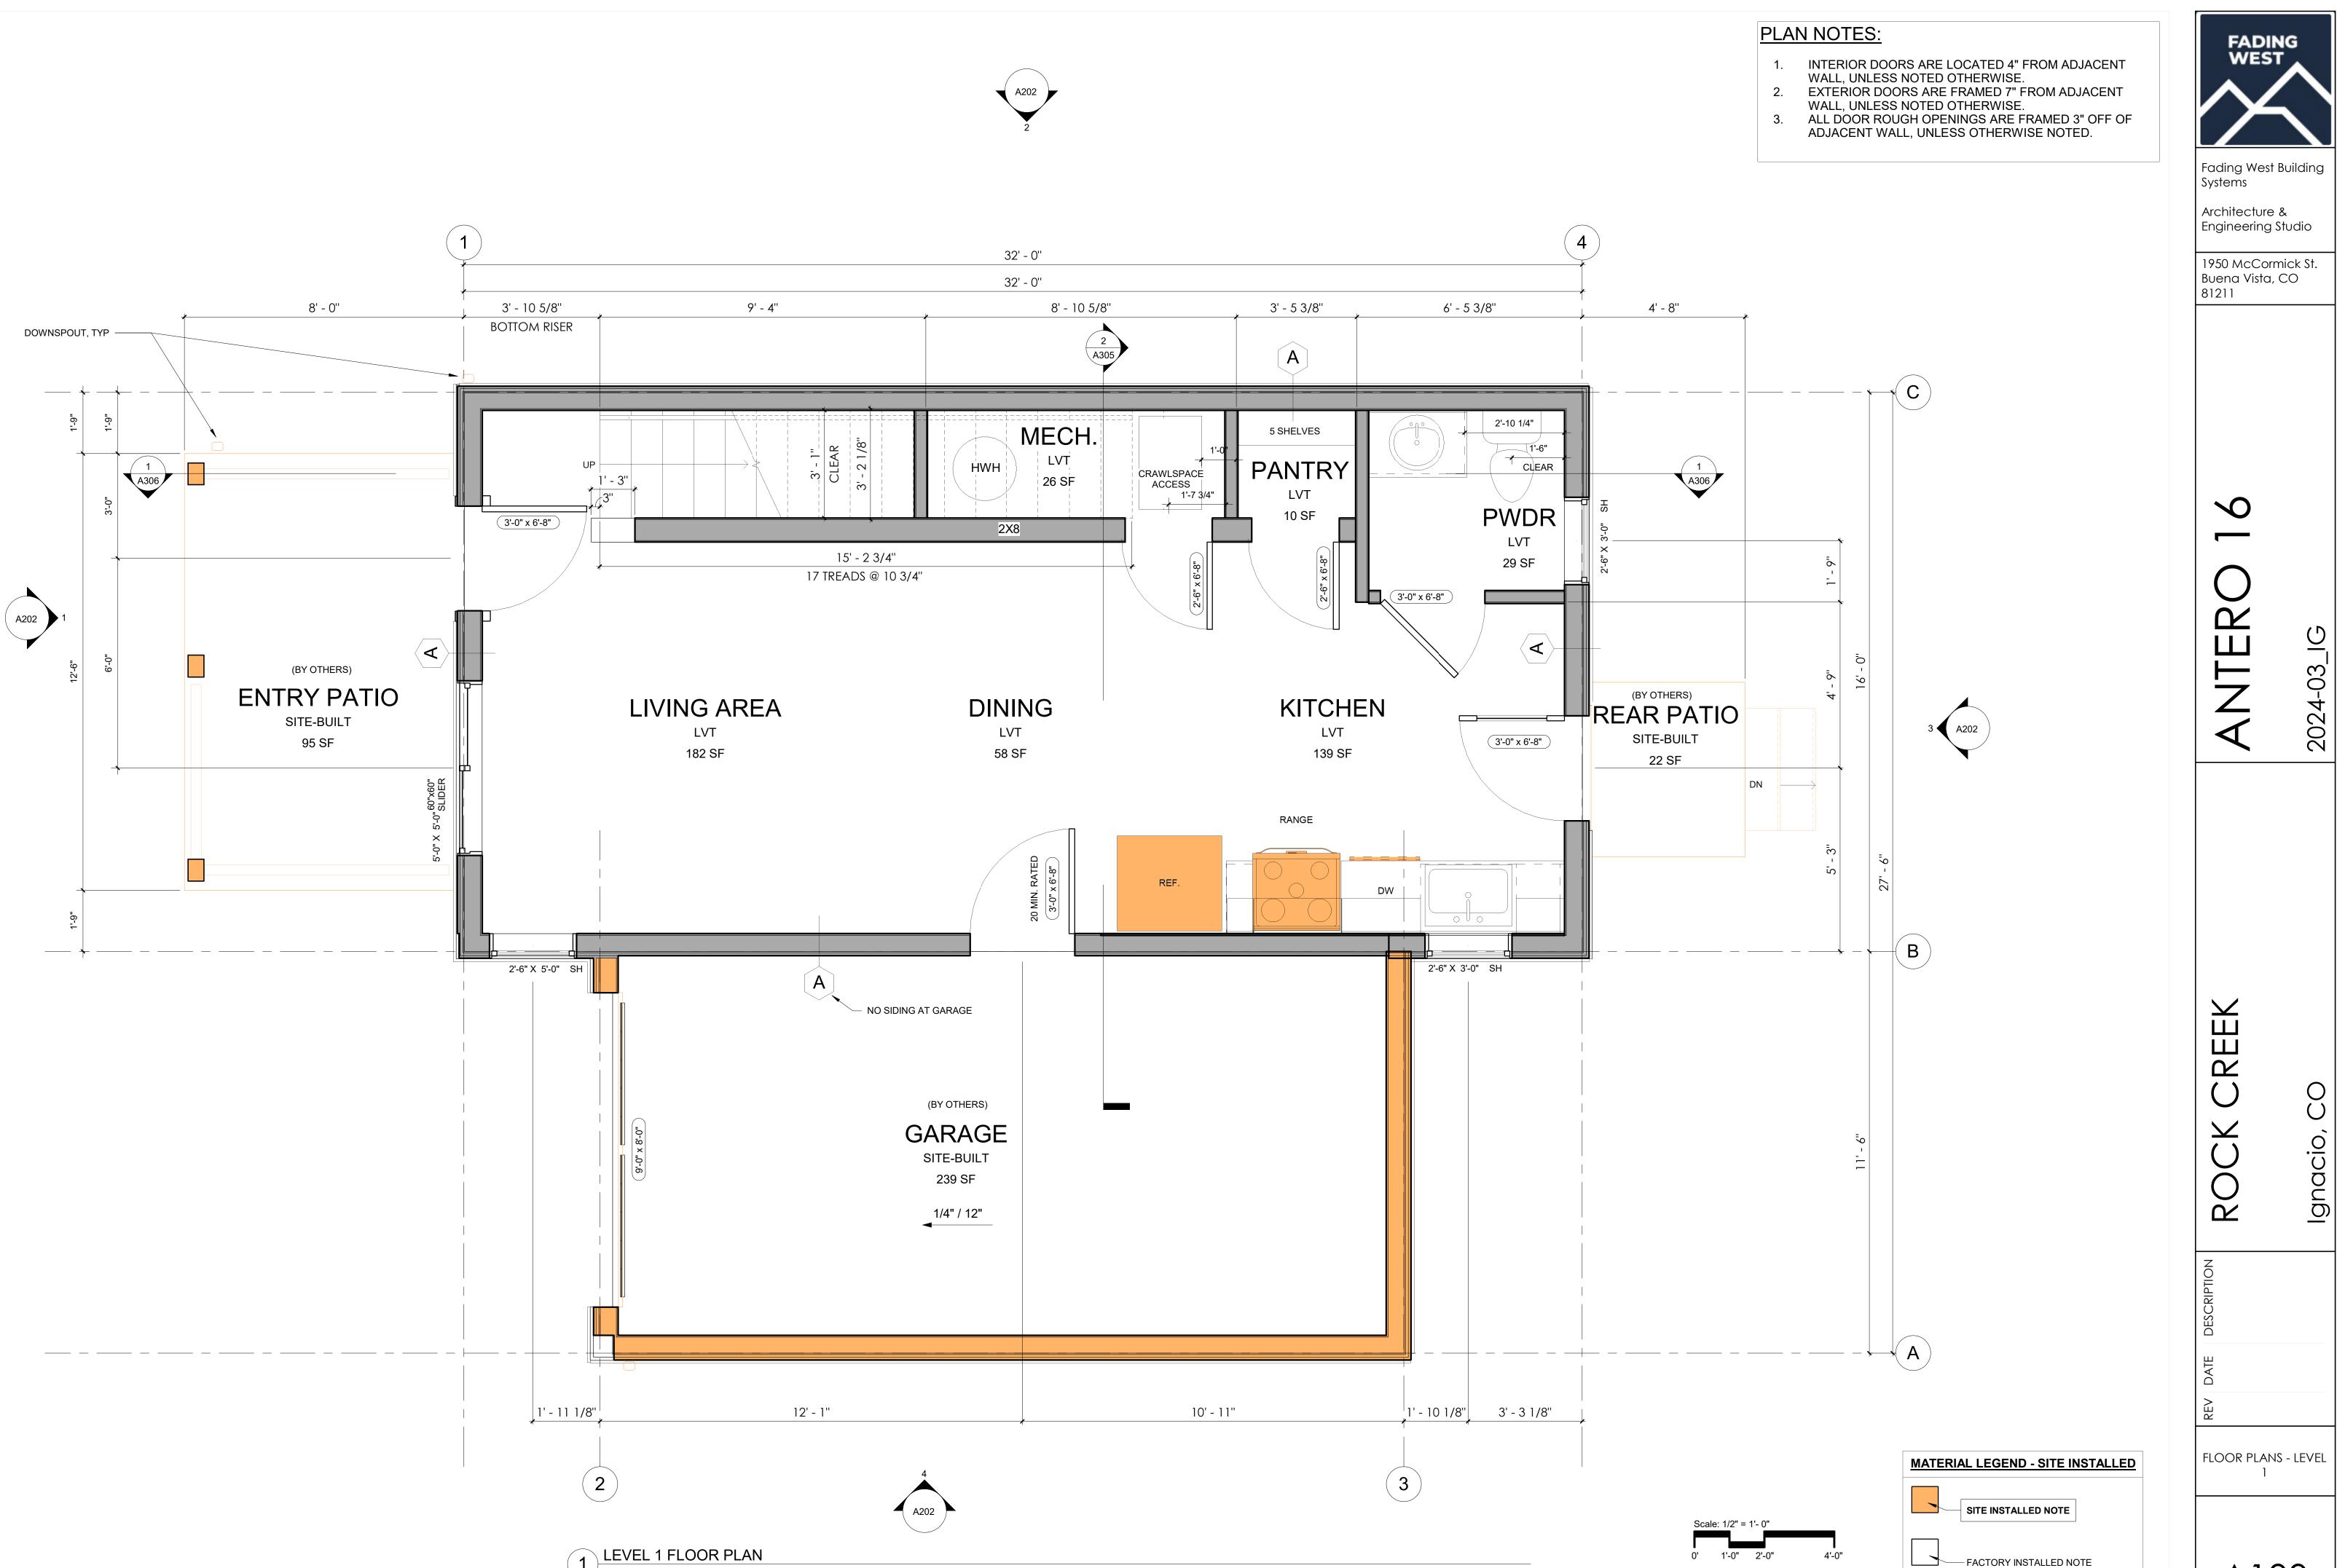
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A100





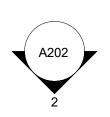

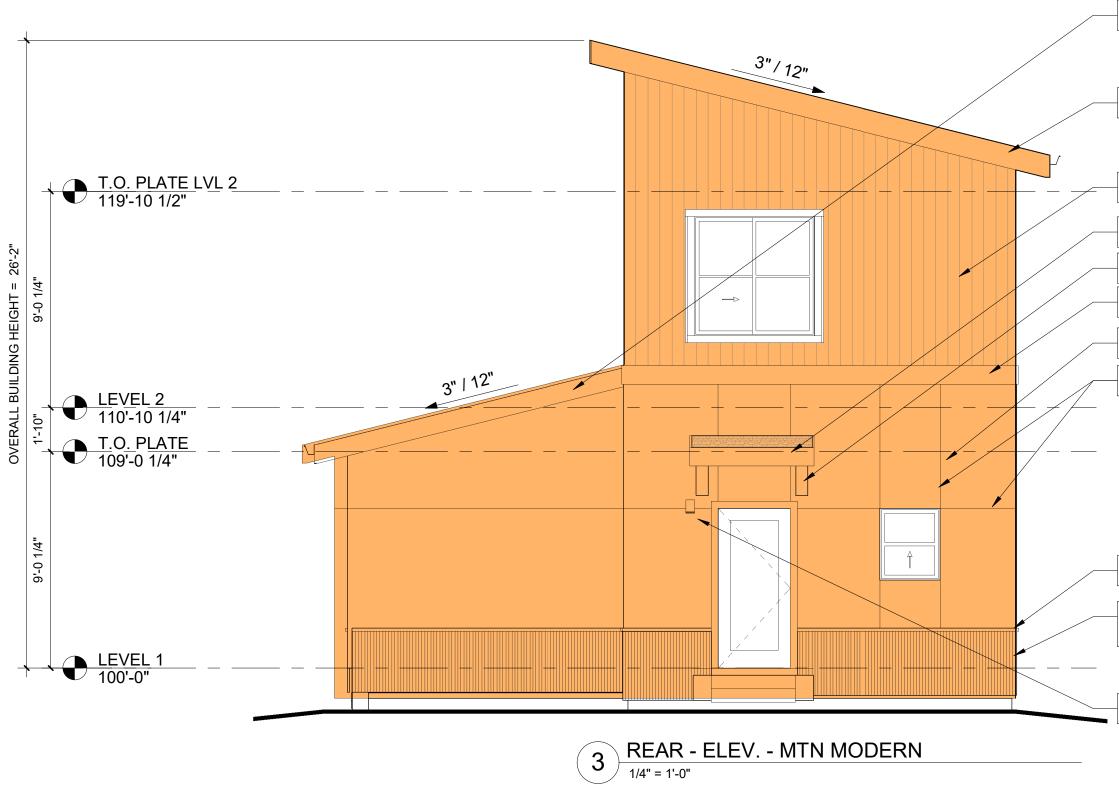


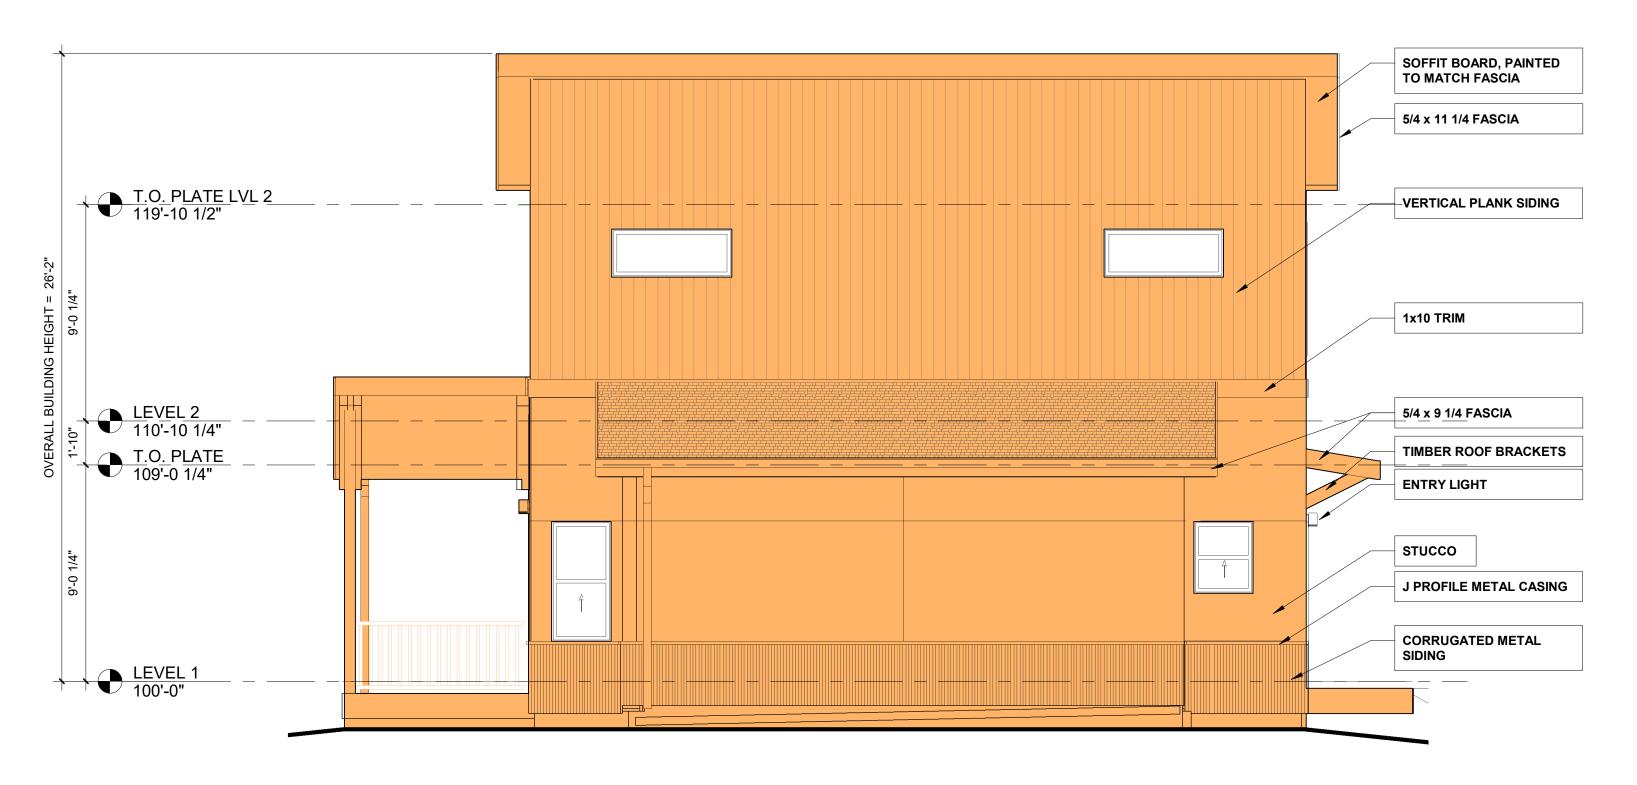
4 RIGHT - ELEV. - MTN MODERN 1/4" = 1'-0"


5/4 x 9 1/4 FASCIA
5/4 x 11 1/4 FASCIA
VERTICAL PLANK SIDING
5/4 x 9 1/4 FASCIA
TIMBER ROOF BRACKETS
1x10 TRIM
STUCCO
CONTROL JOINTS, TYP




CORRUGATED METAL SIDING

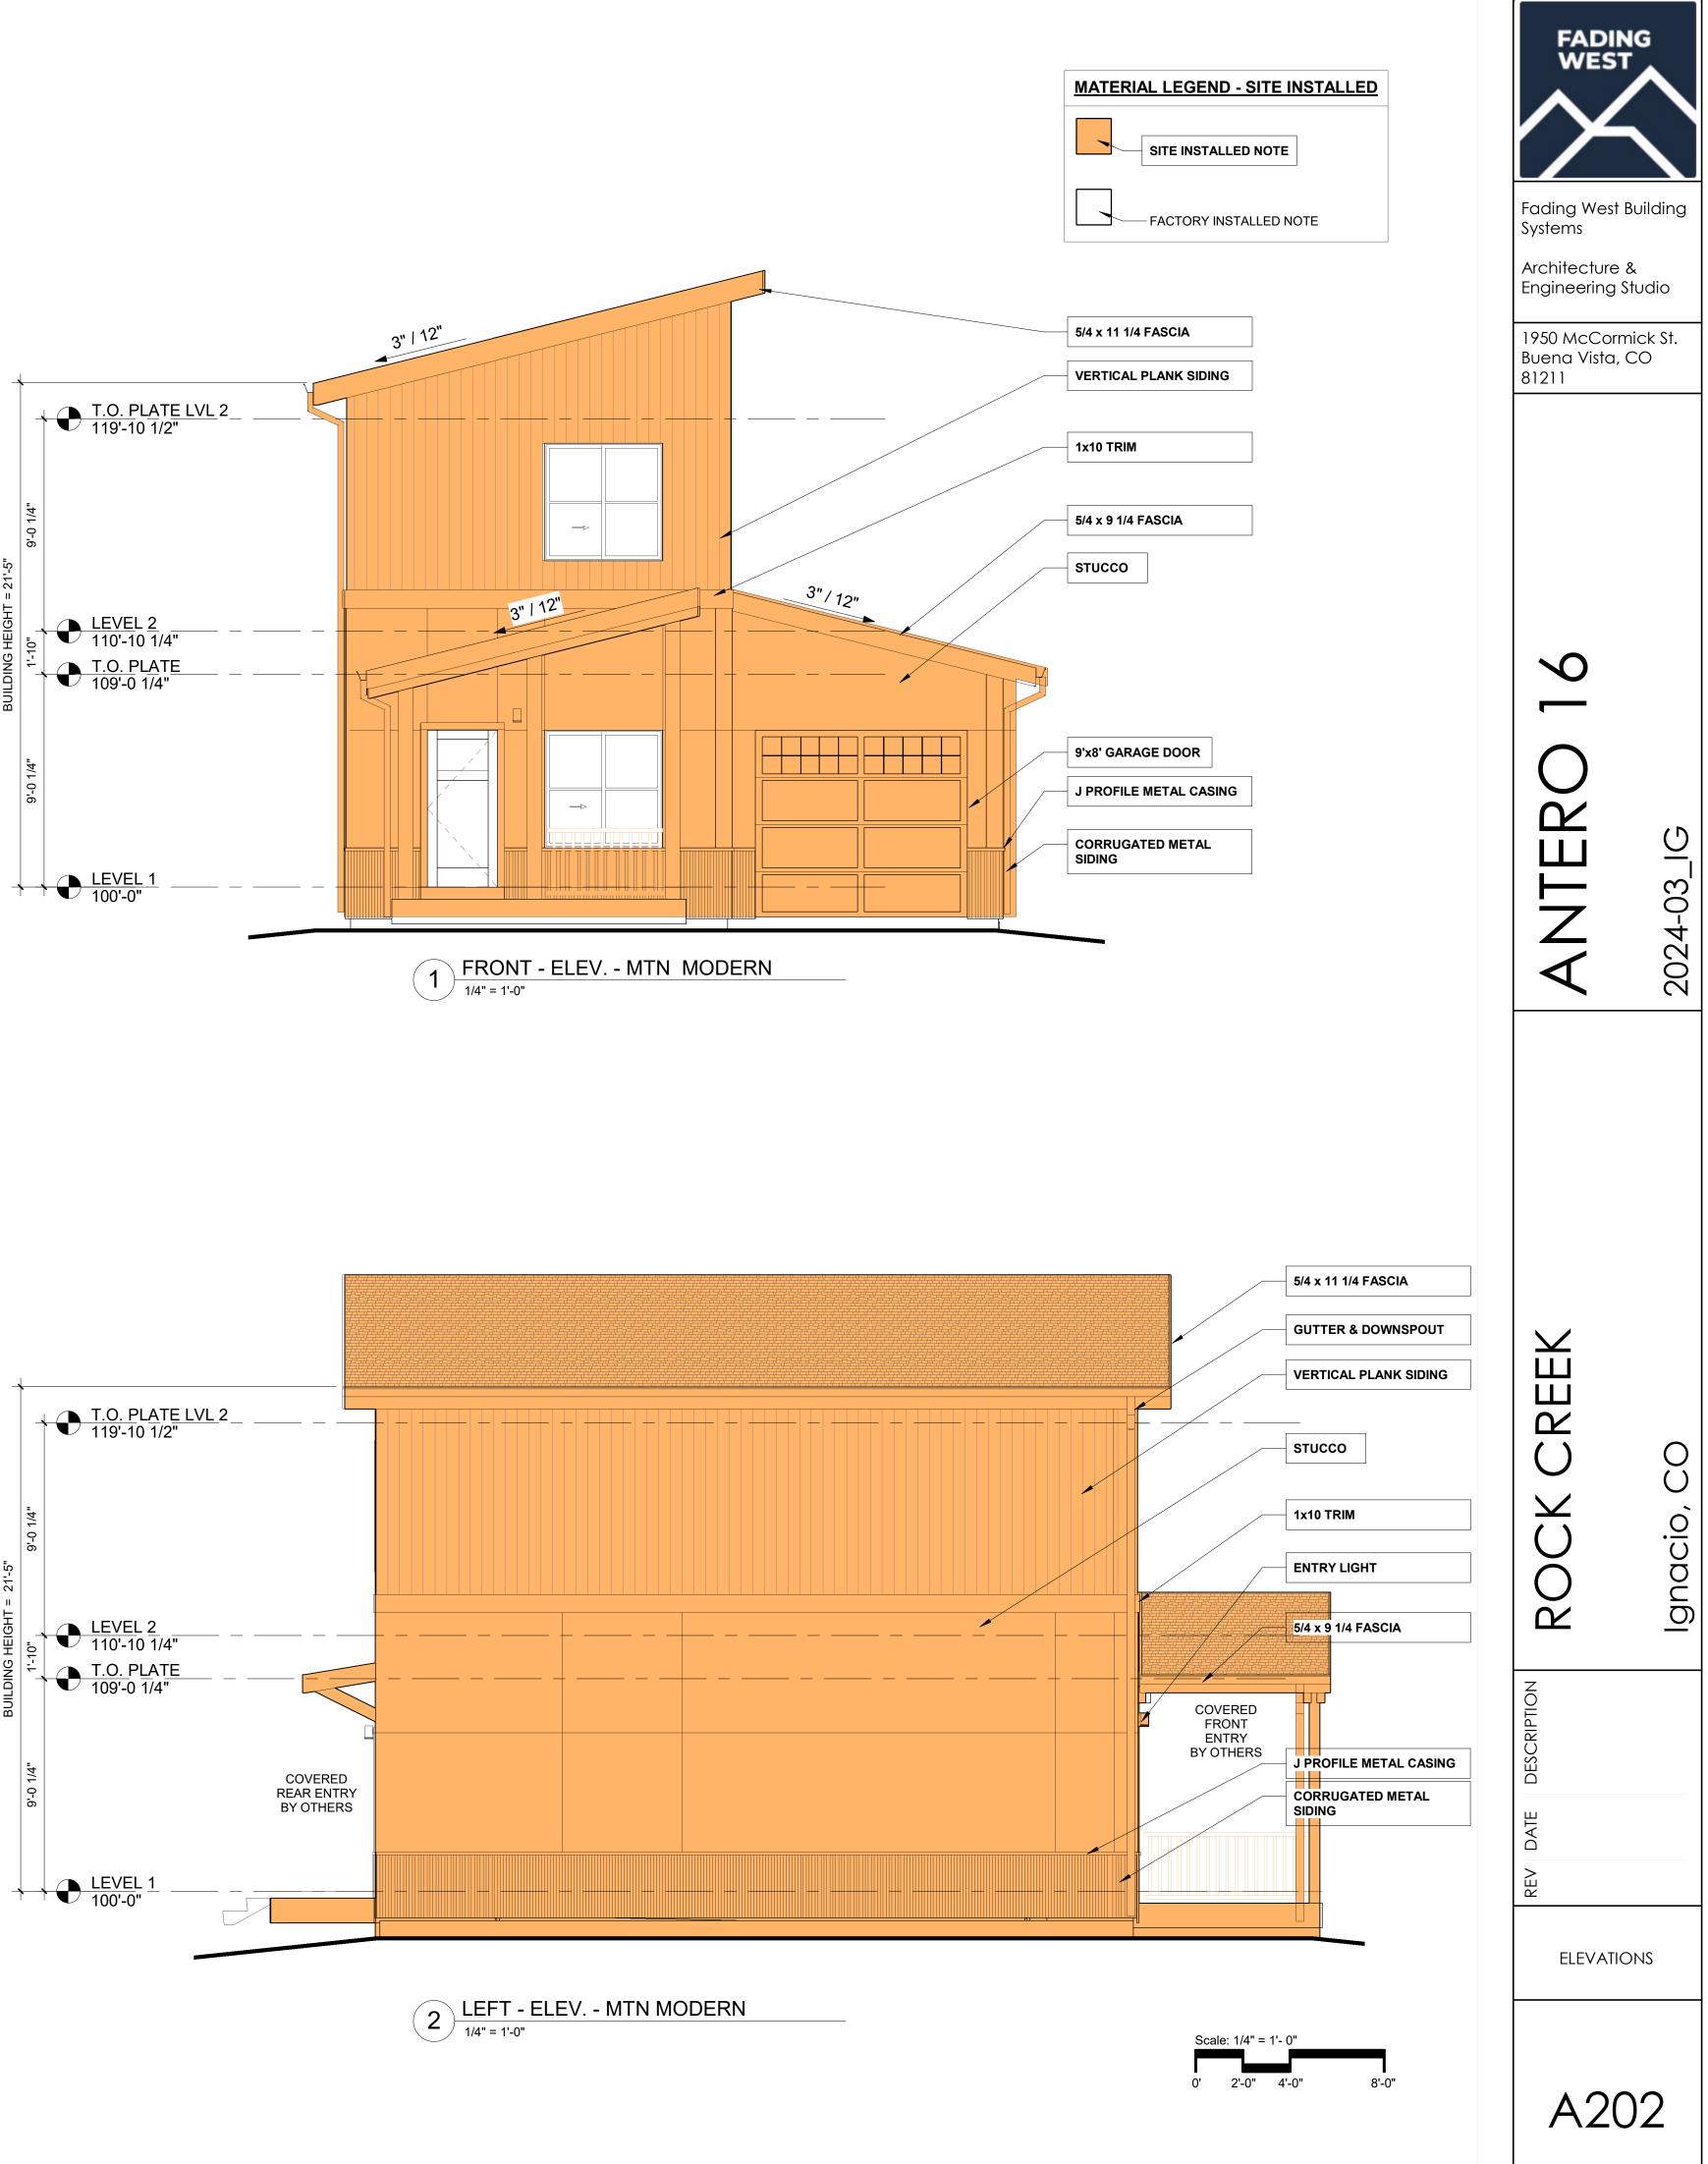

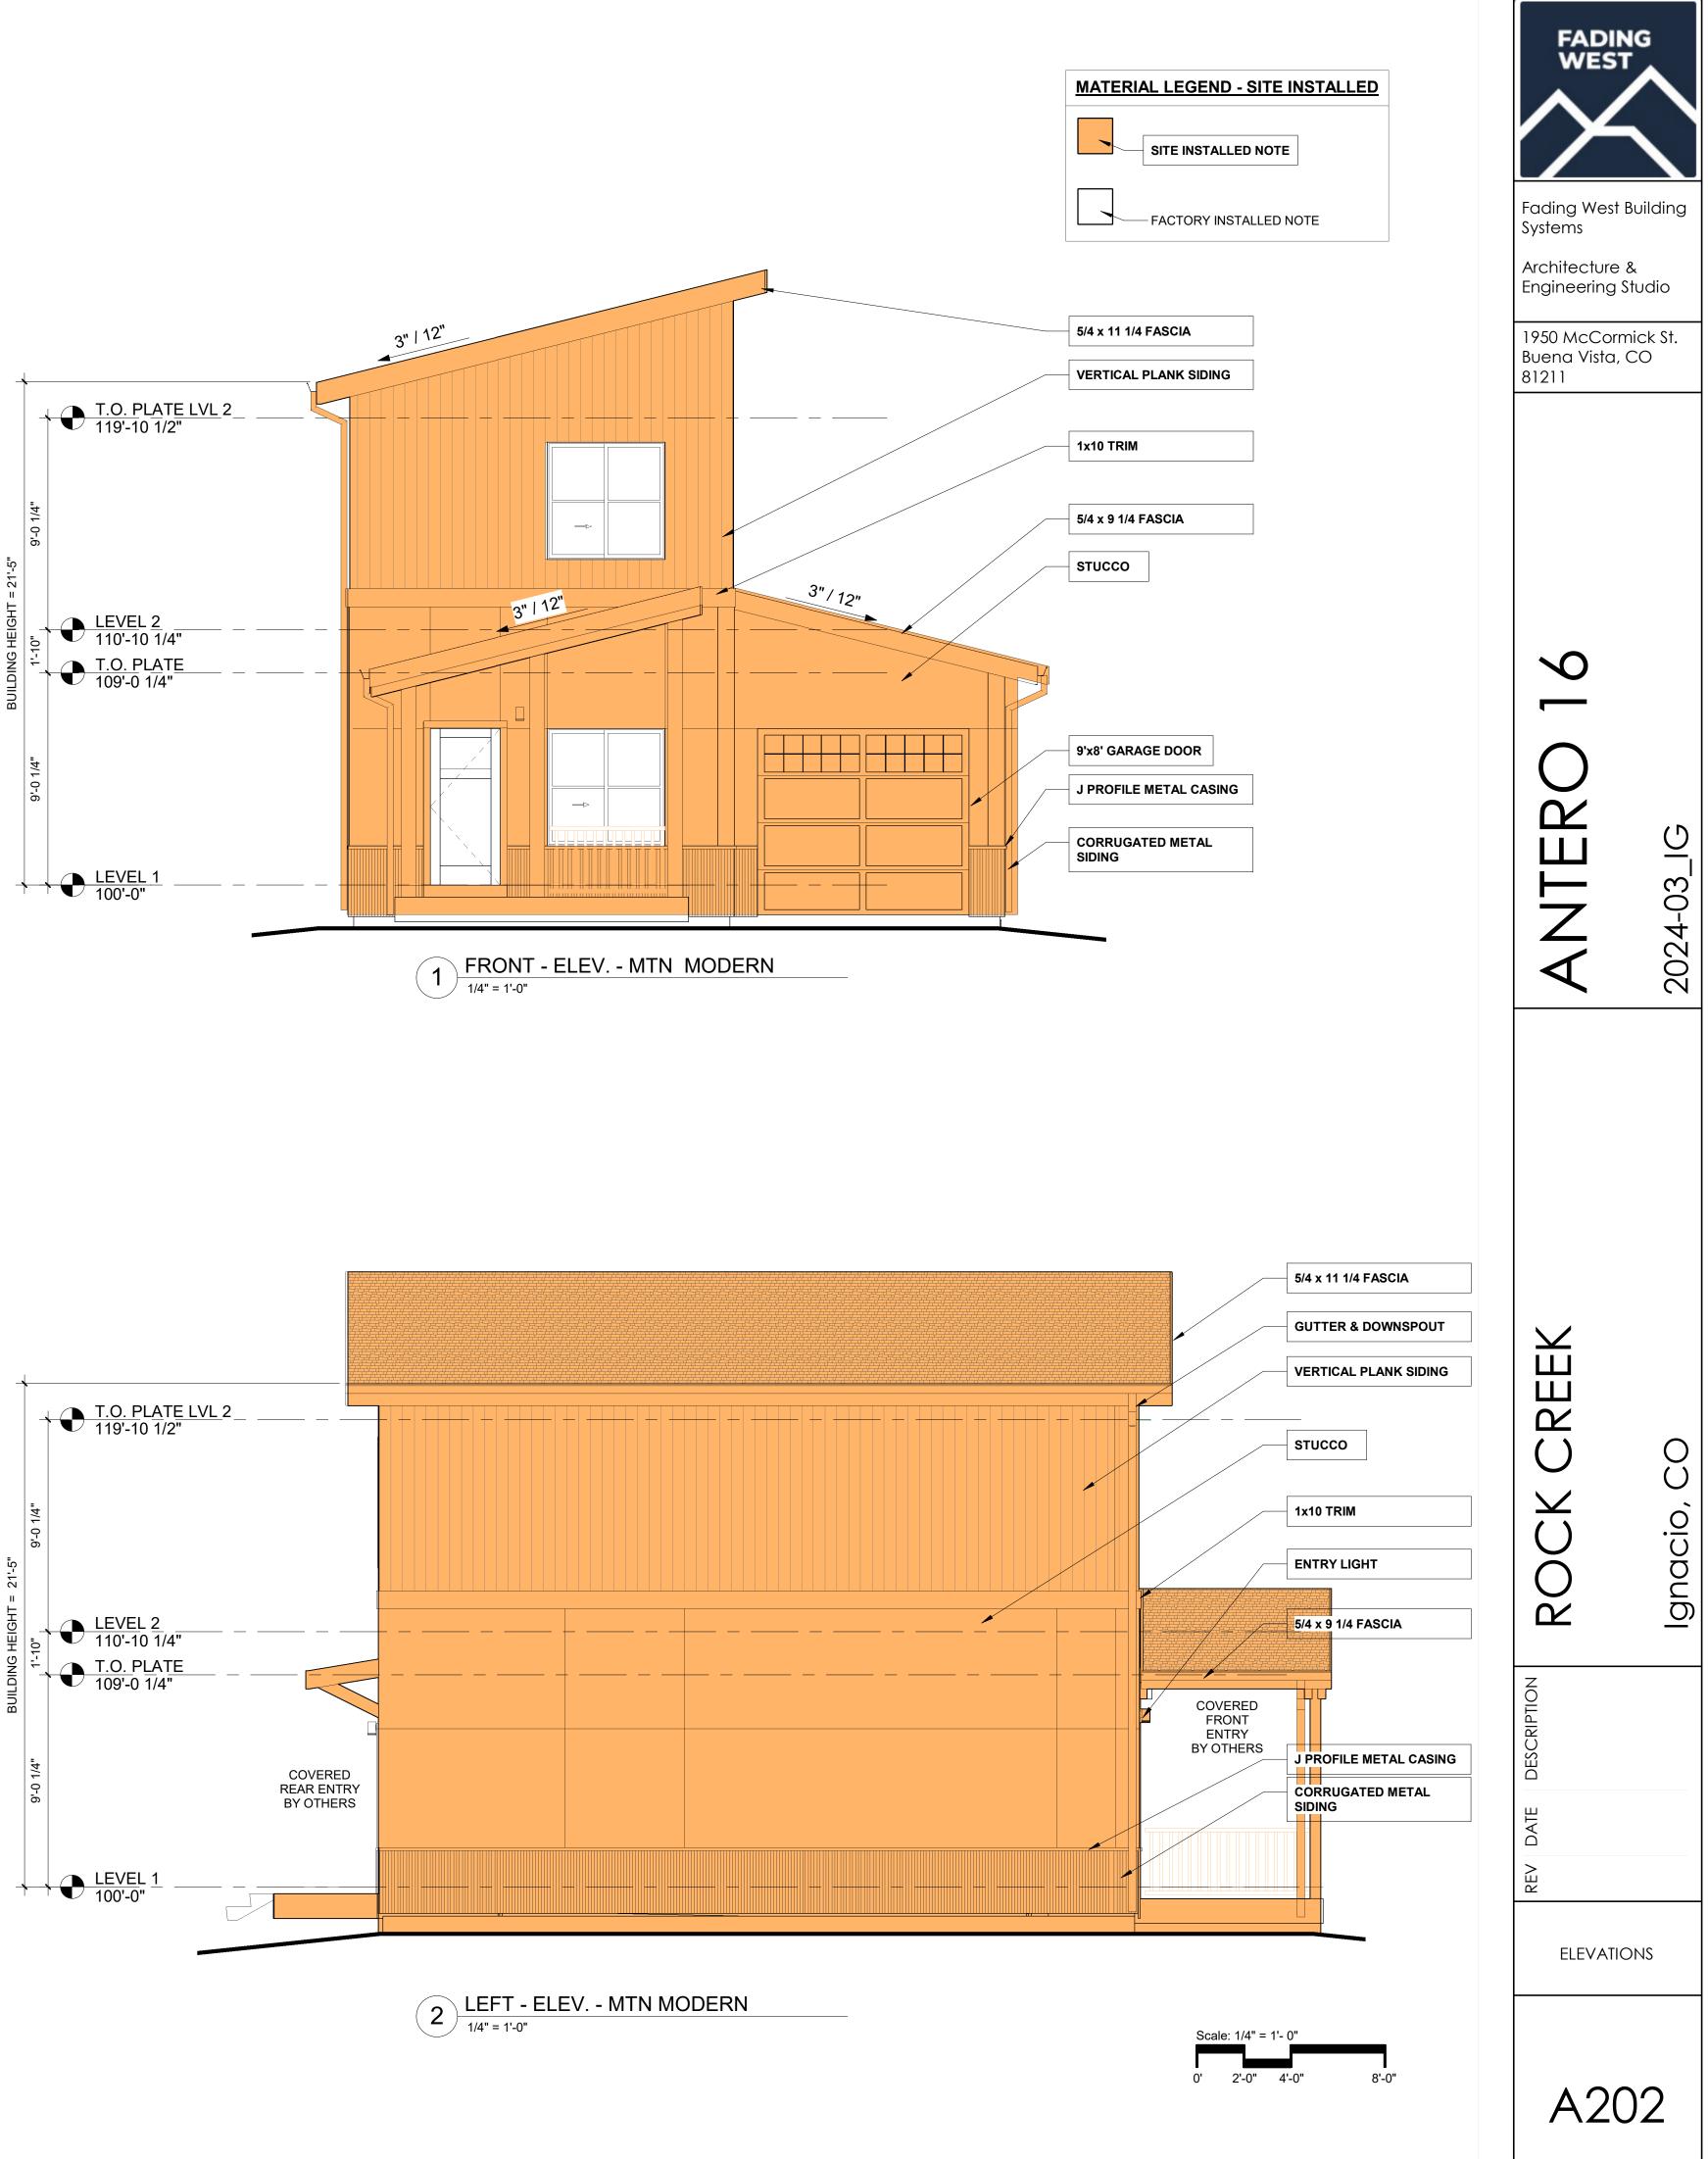


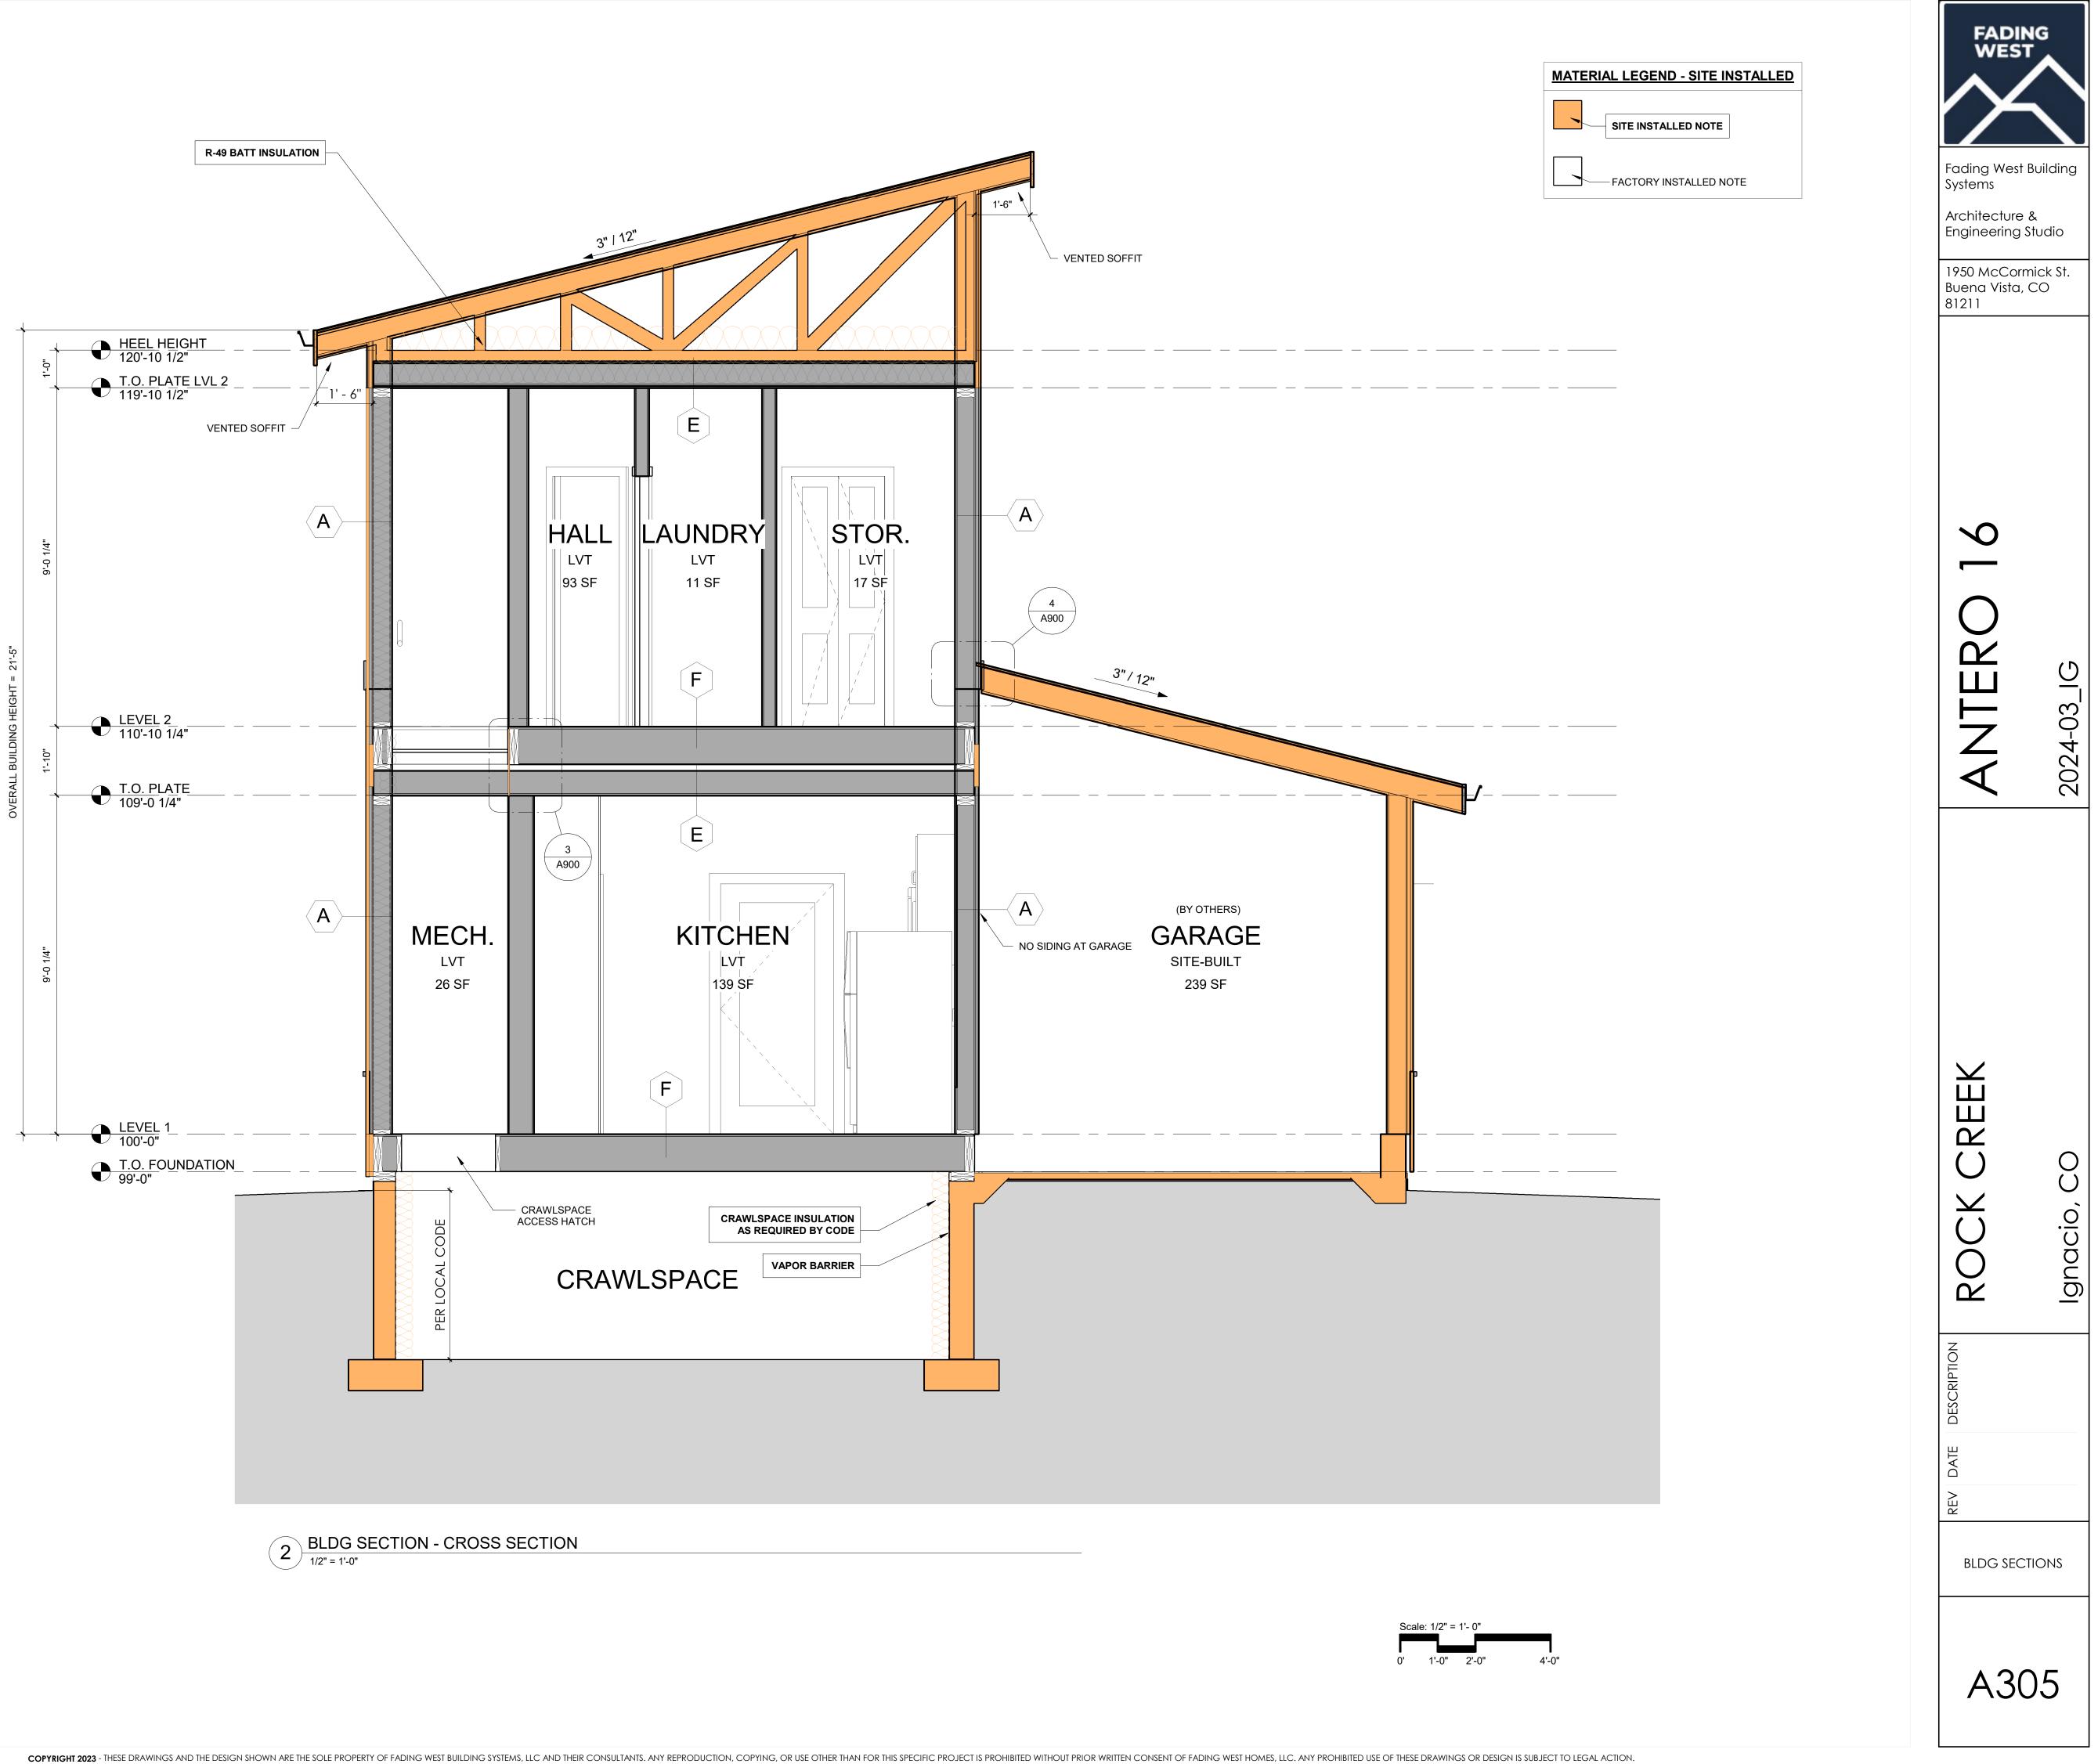




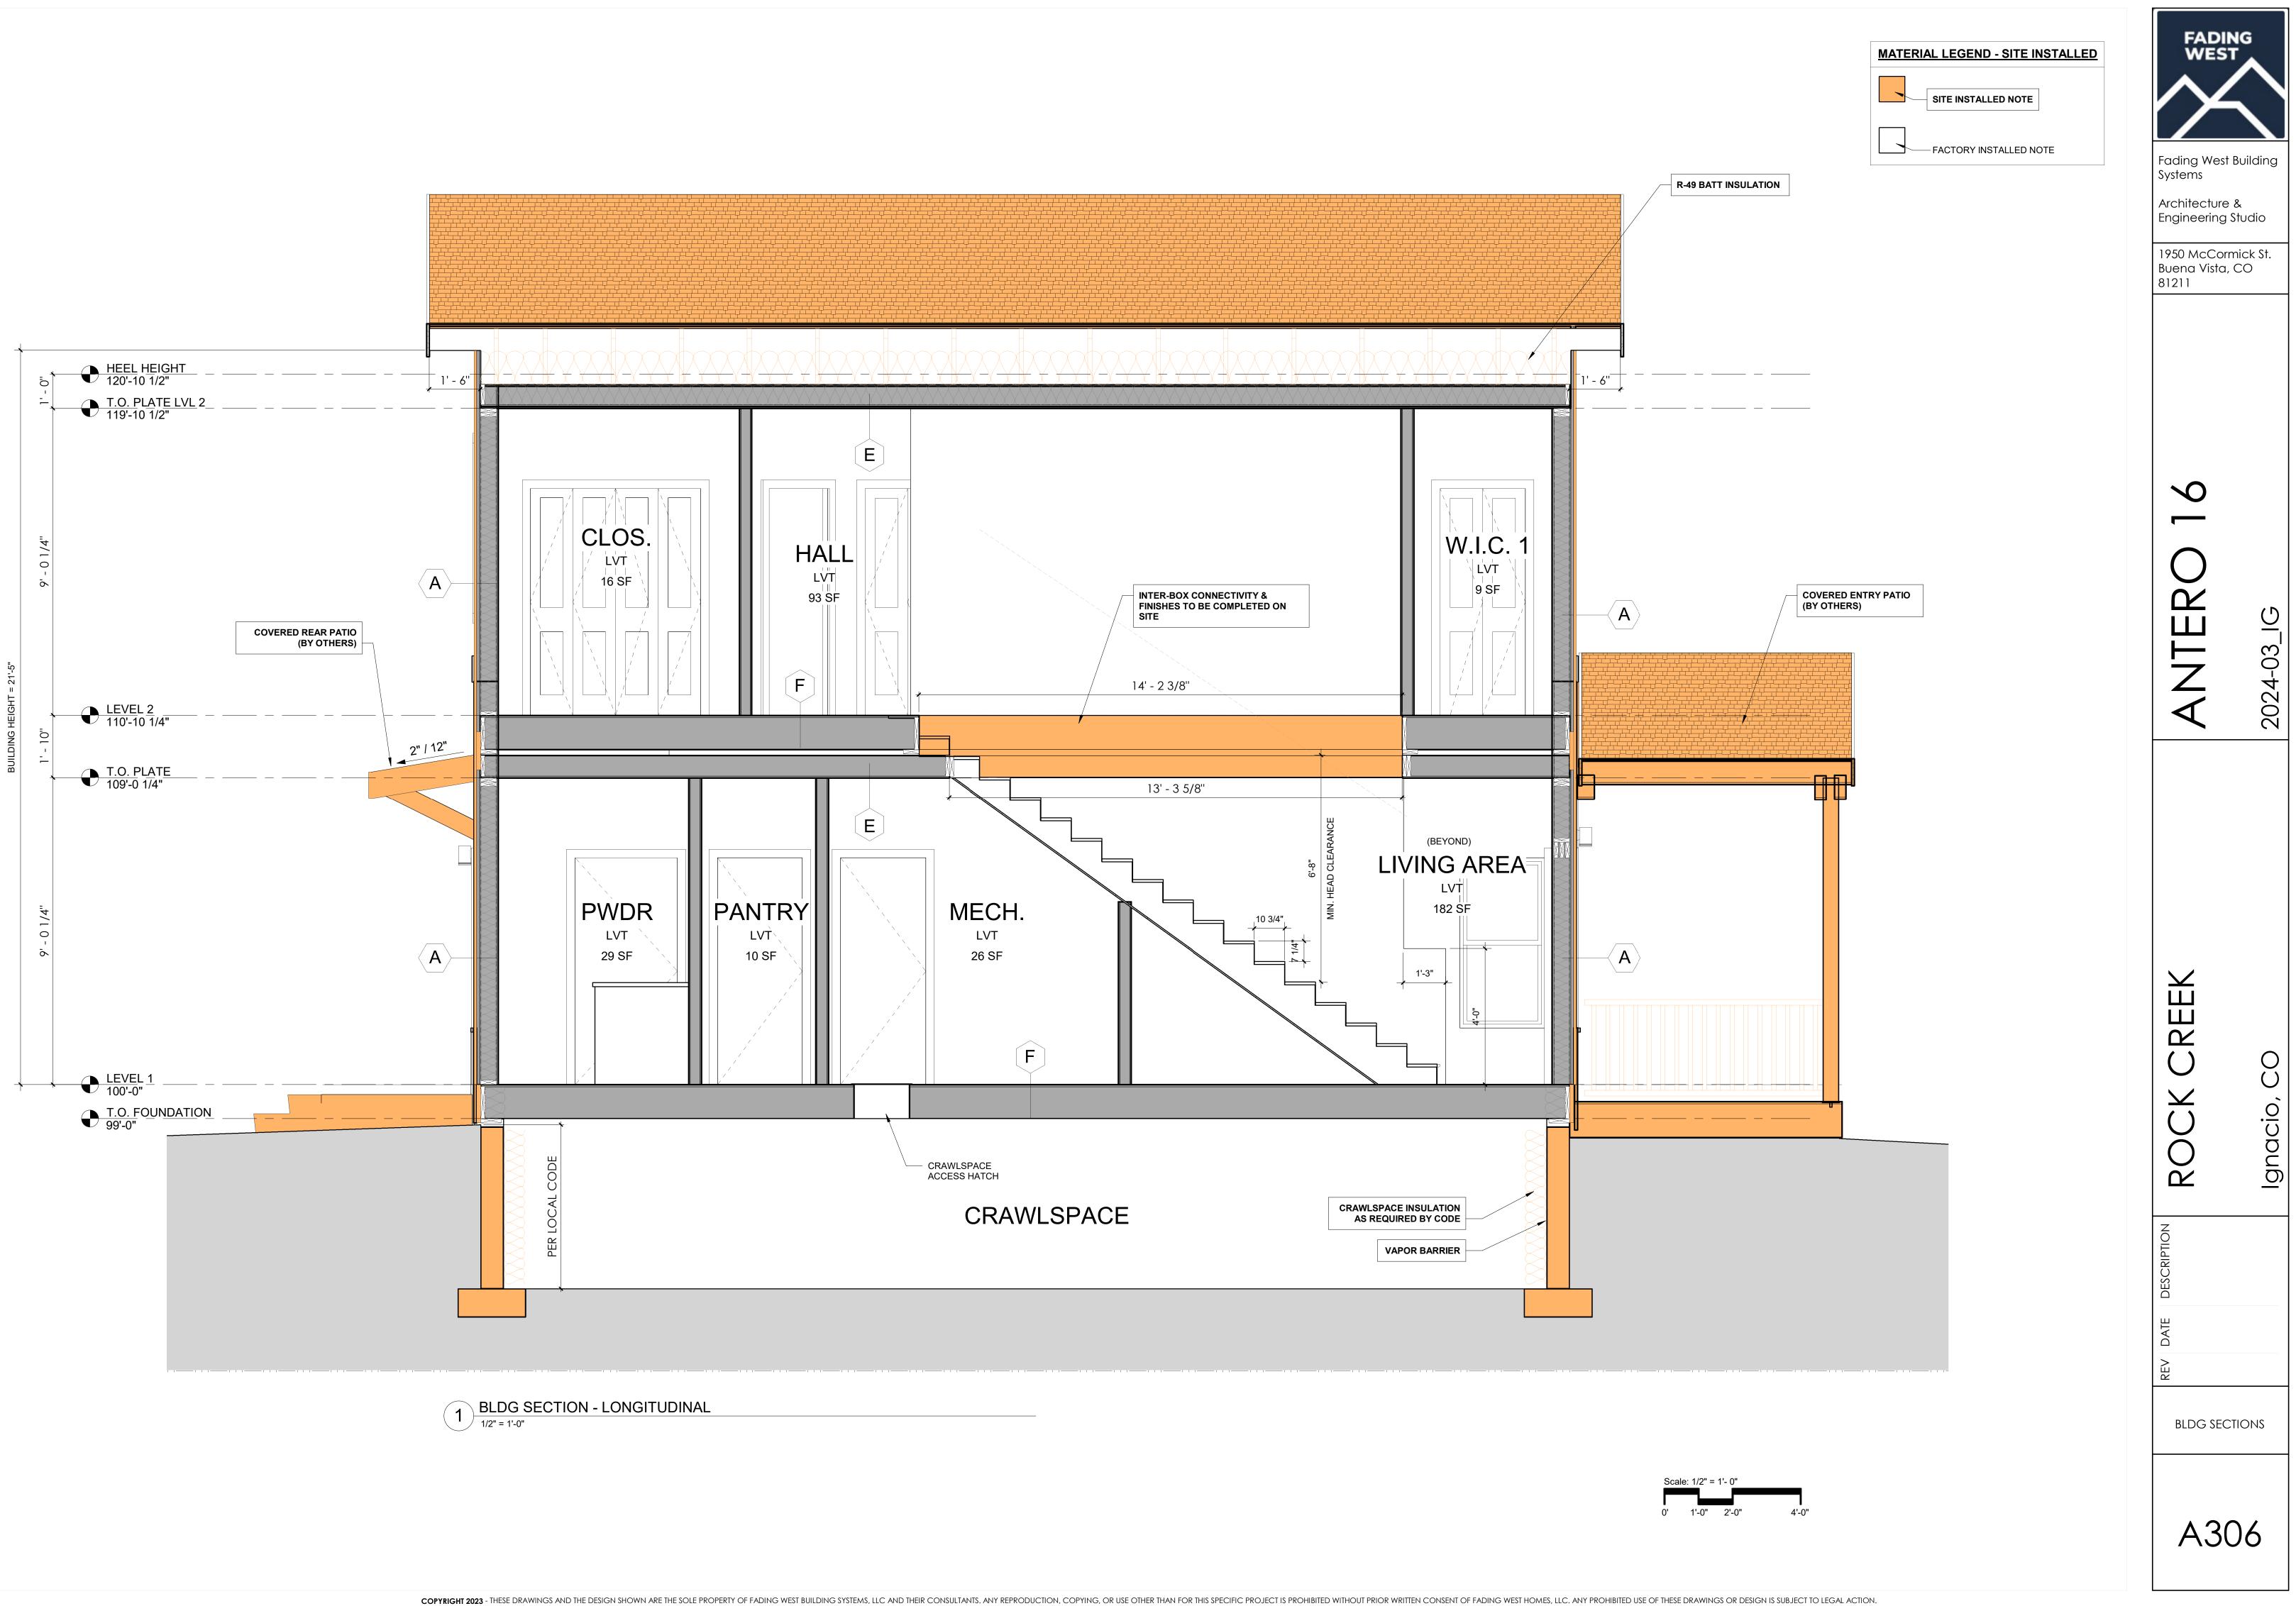

Door Schedule				
Width	Height	Туре	Comments	Count
2'-6"	6'-8"	Door Bifold 2 Panel: 4-3080	2 PANEL BIFOLD	3
5'-0"	6'-8"	Door Bifold 4 Panel1: 5-6080	4 PANEL BIFOLD	1
3'-0"	6'-8"	Door Flush Adj Swing2: 3'-0"x6'-8" - 20 Min Rated	EXT SW 20 MIN. RATED	1
2'-6"	6'-8"	Door Flush Left Swing: 2'-6"x6'-8"	INT SW	2
2'-6"	6'-8"	Door Flush Right Swing: 2'-6"x6'-8"	INT SW	3
3'-0"	6'-8"	Door Flush Right Swing: 3'-0"x6'-8"	INT SW	1
3'-0"	6'-8"	Exterior Door Front Door1: 1.1-3680	FRONT DOOR (QUARTER LITE)	1
9'-0"	8'-0"	Overhead-Sectional_Decorative_Door001_2346: 8' x 6'-6"	SITE-BUILT BY OTHERS	1
3'-0"	6'-8"	Single-Full Glass: 36" x 84"	REAR DOOR (FULL LITE)	1

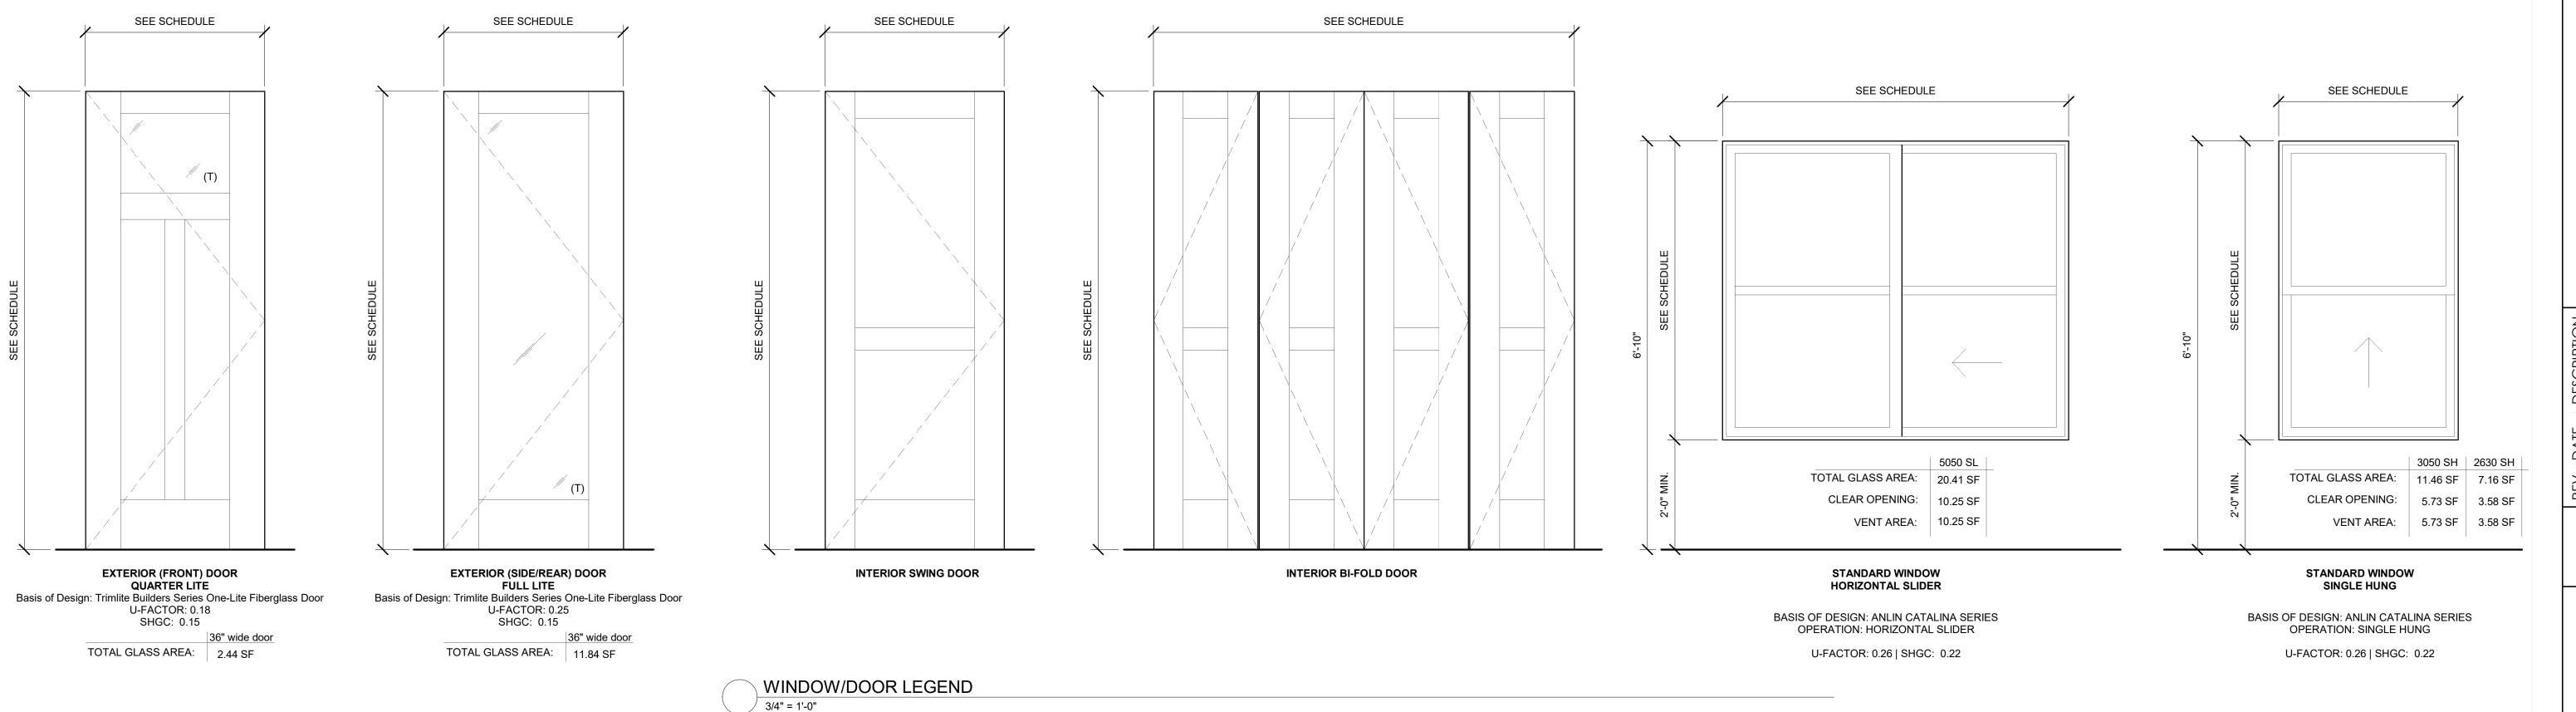

Window Schedule				
Width	Height	Family and Type	Count	
2'-6"	3'-0"	FW - Window Single Hung2: 2'6" x 3'0"	2	
2'-6"	5'-0"	FW - Window Single Hung2: 2'6" x 5'0"	1	
5'-0"	2'-0"	Fixed: 5'-0"x 2'-0"	2	
5'-0"	5'-0"	FW - Window Slider: E-6060	3	

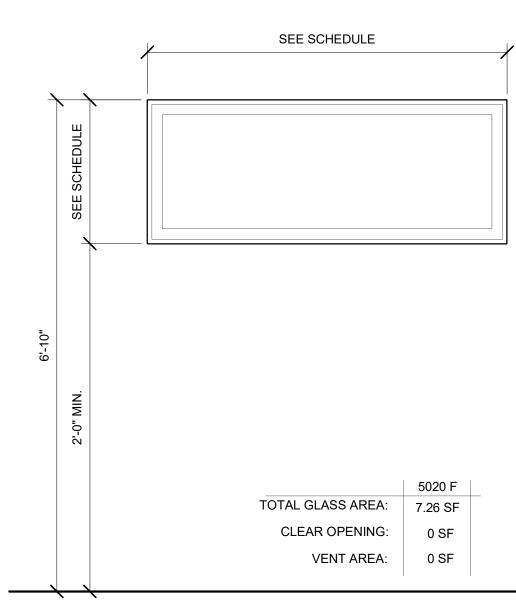

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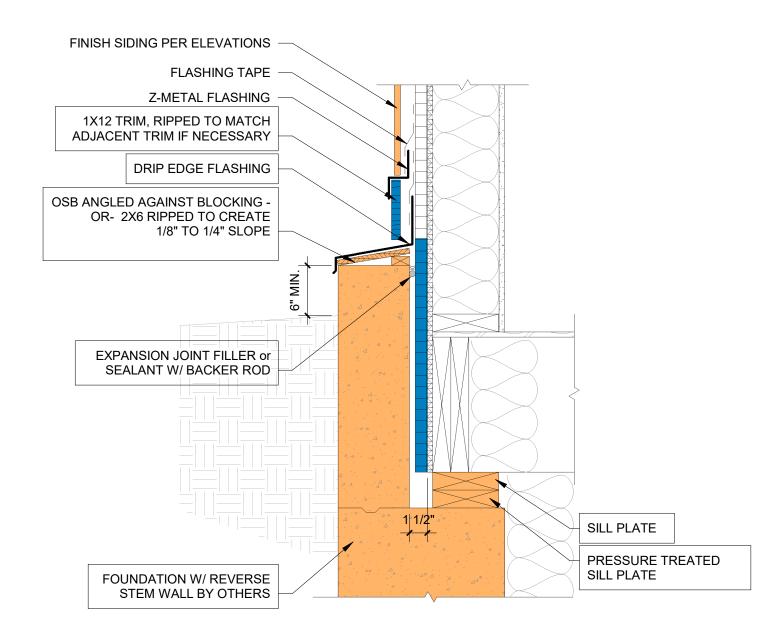
STANDARD WINDOW FIXED


BASIS OF DESIGN: ANLIN CATALINA SERIES OPERATION: FIXED

U-FACTOR: 0.26 | SHGC: 0.22

	G
Fading West Bu Systems Architecture & Engineering Str 1950 McCormi Buena Vista, C 81211	udio ck St.
ANTERO 16	2024-03_IG
DATE DESCRIPTION ROCK CREEK	Ignacio, CO
WINDOW/DO SCHEDULI	
A40	0





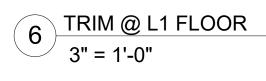

SECTION VIEW

